


STATE OF UTAH
DEPARTMENT OF NATURAL RESOURCES
DIVISION OF OIL, GAS AND MINING

FORM 3

AMENDED REPORT ☐

APPLICATION FOR PERMIT TO DRILL						1. WELL NAME and NUMBER GMBU P-33-8-17							
2. TYPE OF WORK DRILL NEW WELL <input checked="" type="checkbox"/> REENTER P&A WELL <input type="checkbox"/> DEEPEN WELL <input type="checkbox"/>						3. FIELD OR WILDCAT MONUMENT BUTTE							
4. TYPE OF WELL Oil Well Coalbed Methane Well: NO						5. UNIT or COMMUNITIZATION AGREEMENT NAME GMBU (GRRV)							
6. NAME OF OPERATOR NEWFIELD PRODUCTION COMPANY						7. OPERATOR PHONE 435 646-4825							
8. ADDRESS OF OPERATOR Rt 3 Box 3630 , Myton, UT, 84052						9. OPERATOR E-MAIL mcrozier@newfield.com							
10. MINERAL LEASE NUMBER (FEDERAL, INDIAN, OR STATE) UTU-77234			11. MINERAL OWNERSHIP FEDERAL <input checked="" type="checkbox"/> INDIAN <input type="checkbox"/> STATE <input type="checkbox"/> FEE <input type="checkbox"/>			12. SURFACE OWNERSHIP FEDERAL <input checked="" type="checkbox"/> INDIAN <input type="checkbox"/> STATE <input type="checkbox"/> FEE <input type="checkbox"/>							
13. NAME OF SURFACE OWNER (if box 12 = 'fee')						14. SURFACE OWNER PHONE (if box 12 = 'fee')							
15. ADDRESS OF SURFACE OWNER (if box 12 = 'fee')						16. SURFACE OWNER E-MAIL (if box 12 = 'fee')							
17. INDIAN ALLOTTEE OR TRIBE NAME (if box 12 = 'INDIAN')			18. INTEND TO COMMINGLE PRODUCTION FROM MULTIPLE FORMATIONS YES <input type="checkbox"/> (Submit Commingling Application) NO <input checked="" type="checkbox"/>			19. SLANT VERTICAL <input type="checkbox"/> DIRECTIONAL <input checked="" type="checkbox"/> HORIZONTAL <input type="checkbox"/>							
20. LOCATION OF WELL		FOOTAGES		QTR-QTR		SECTION		TOWNSHIP		RANGE		MERIDIAN	
LOCATION AT SURFACE		2073 FSL 911 FEL		NESE		32		8.0 S		17.0 E		S	
Top of Uppermost Producing Zone		1583 FSL 360 FEL		NESE		32		8.0 S		17.0 E		S	
At Total Depth		1057 FSL 270 FWL		SWSW		33		8.0 S		17.0 E		S	
21. COUNTY DUCHESNE			22. DISTANCE TO NEAREST LEASE LINE (Feet) 270			23. NUMBER OF ACRES IN DRILLING UNIT 20							
			25. DISTANCE TO NEAREST WELL IN SAME POOL (Applied For Drilling or Completed) 1480			26. PROPOSED DEPTH MD: 6469 TVD: 6225							
27. ELEVATION - GROUND LEVEL 5192			28. BOND NUMBER WYB000493			29. SOURCE OF DRILLING WATER / WATER RIGHTS APPROVAL NUMBER IF APPLICABLE 437478							
Hole, Casing, and Cement Information													
String	Hole Size	Casing Size	Length	Weight	Grade & Thread	Max Mud Wt.	Cement		Sacks	Yield	Weight		
Surf	12.25	8.625	0 - 300	24.0	J-55 ST&C	8.3	Class G		138	1.17	15.8		
Prod	7.875	5.5	0 - 6469	15.5	J-55 LT&C	8.3	Premium Lite High Strength		309	3.26	11.0		
							50/50 Poz		363	1.24	14.3		
ATTACHMENTS													
VERIFY THE FOLLOWING ARE ATTACHED IN ACCORDANCE WITH THE UTAH OIL AND GAS CONSERVATION GENERAL RULES													
<input checked="" type="checkbox"/> WELL PLAT OR MAP PREPARED BY LICENSED SURVEYOR OR ENGINEER						<input checked="" type="checkbox"/> COMPLETE DRILLING PLAN							
<input type="checkbox"/> AFFIDAVIT OF STATUS OF SURFACE OWNER AGREEMENT (IF FEE SURFACE)						<input type="checkbox"/> FORM 5. IF OPERATOR IS OTHER THAN THE LEASE OWNER							
<input checked="" type="checkbox"/> DIRECTIONAL SURVEY PLAN (IF DIRECTIONALLY OR HORIZONTALLY DRILLED)						<input checked="" type="checkbox"/> TOPOGRAPHICAL MAP							
NAME Mandie Crozier					TITLE Regulatory Tech					PHONE 435 646-4825			
SIGNATURE					DATE 10/26/2011					EMAIL mcrozier@newfield.com			
API NUMBER ASSIGNED 43013510260000					APPROVAL  Permit Manager								

RECEIVED: November 08, 2011

NEWFIELD PRODUCTION COMPANY
GMBU P-33-8-17
AT SURFACE: NE/SE SECTION 32, T8S, R17E
DUCHESNE COUNTY, UTAH

TEN POINT DRILLING PROGRAM

1. **GEOLOGIC SURFACE FORMATION:**

Uinta formation of Upper Eocene Age

2. **ESTIMATED TOPS OF IMPORTANT GEOLOGIC MARKERS:**

Uinta	0' – 1455'
Green River	1455'
Wasatch	6185'
Proposed TD	6469'

3. **ESTIMATED DEPTHS OF ANTICIPATED WATER, OIL, GAS OR MINERALS:**

Green River Formation (Oil) 1455' – 6185'

Fresh water may be encountered in the Uinta Formation, but would not be expected below about 350'. All water shows and water bearing geologic units shall be reported to the geologic and engineering staff of the Vernal Office prior to running the next string of casing or before plugging orders are requested. All water shows must be reported within one (1) business day after being encountered.

All usable (<10,000 PPM TDS) water and prospectively valuable minerals (as described by BLM at onsite) encountered during drilling will be recorded by depth and adequately protected. This information shall be reported to the Vernal Office.

Detected water flows shall be sampled, analyzed, and reported to the geologic & engineering staff of the Vernal Office. The office may request additional water samples for further analysis. Usage of the State of Utah form *Report of Water Encountered* is acceptable, but not required.

The following information is requested for water shows and samples where applicable:

Location & Sampled Interval	Date Sampled
Flow Rate	Temperature
Hardness	pH
Water Classification (State of Utah)	Dissolved Calcium (Ca) (mg/l)
Dissolved Iron (Fe) (ug/l)	Dissolved Sodium (Na) (mg/l)
Dissolved Magnesium (Mg) (mg/l)	Dissolved Carbonate (CO ₃) (mg/l)
Dissolved Bicarbonate (NaHCO ₃) (mg/l)	Dissolved Chloride (Cl) (mg/l)
Dissolved Sulfate (SO ₄) (mg/l)	Dissolved Total Solids (TDS) (mg/l)

4. **PROPOSED CASING PROGRAM**

a. Casing Design: GMBU P-33-8-17

Size	Interval		Weight	Grade	Coupling	Design Factors		
	Top	Bottom				Burst	Collapse	Tension
Surface casing 8-5/8"	0'	300'	24.0	J-55	STC	2,950 17.53	1,370 14.35	244,000 33.89
Prod casing 5-1/2"	0'	6,469'	15.5	J-55	LTC	4,810 2.34	4,040 1.96	217,000 2.16

Assumptions:

- 1) Surface casing max anticipated surface press (MASP) = Frac gradient – gas gradient
- 2) Prod casing MASP (production mode) = Pore pressure – gas gradient
- 3) All collapse calculations assume fully evacuated casing w/ gas gradient
- 4) All tension calculations assume air weight

Frac gradient at surface casing shoe = 13.0 ppg
 Pore pressure at surface casing shoe = 8.33 ppg
 Pore pressure at prod casing shoe = 8.33 ppg
 Gas gradient = 0.115 psi/ft

All casing shall be new or, if used, inspected and tested. Used casing shall meet or exceed API standards for new casing.

All casing strings shall have a minimum of 1 (one) centralizer on each of the bottom three (3) joints.

b. Cementing Design: GMBU P-33-8-17

Job	Fill	Description	Sacks	OH Excess*	Weight (ppg)	Yield (ft ³ /sk)
			ft ³			
Surface casing	300'	Class G w/ 2% CaCl	138 161	30%	15.8	1.17
Prod casing Lead	4,469'	Prem Lite II w/ 10% gel + 3% KCl	309 1007	30%	11.0	3.26
Prod casing Tail	2,000'	50/50 Poz w/ 2% gel + 3% KCl	363 451	30%	14.3	1.24

*Actual volume pumped will be 15% over the caliper log

- Compressive strength of lead cement: 1800 psi @ 24 hours, 2250 psi @ 72 hours
- Compressive strength of tail cement: 2500 psi @ 24 hours

Hole Sizes: A 12-1/4" hole will be drilled for the 8-5/8" surface casing. A 7-7/8" hole will be drilled for the 5-1/2" production casing.

The 8-5/8" surface casing shall in all cases be cemented back to surface. In the event that during the primary surface cementing operation the cement does not circulate to surface, or if the cement level should fall back more than 8 feet from surface, then a remedial surface cementing operation shall be performed to insure adequate isolation and stabilization of the surface casing.

5. **MINIMUM SPECIFICATIONS FOR PRESSURE CONTROL:**

The operator's minimum specifications for pressure control equipment are as follows:

An 8" Double Ram Hydraulic unit with a closing unit will be utilized. Function test of BOP's will be check daily.

Refer to **Exhibit C** for a diagram of BOP equipment that will be used on this well.

6. **TYPE AND CHARACTERISTICS OF THE PROPOSED CIRCULATION MUDS:**

From surface to ± 300 feet will be drilled with an air/mist system. The air rig is equipped with a 6 1/2" blooie line that is straight run and securely anchored. The blooie line is used with a discharge less than 100 ft from the wellbore in order to minimize the well pad size. The blooie line is not equipped with an automatic igniter or continuous pilot light and the compressor is located less than 100 ft from the well bore due to the low possibility of combustion with the air dust mixture. The trailer mounted compressor (capacity of 2000 CFM) has a safety shut-off valve which is located 15 feet from the air rig. A truck with 70 bbls of water is on stand by to be used as kill fluid, if necessary. From about ± 300 feet to TD, a fresh water system will be utilized. Clay inhibition and hole stability will be achieved with a KCl substitute additive. This additive will be identified in the APD and reviewed to determine if the reserve pit shall be lined. This fresh water system will typically contain Total Dissolved Solids (TDS) of less than 3000 PPM. Anticipated mud weight is 8.4 lbs/gal. If necessary to control formation fluids or pressure, the system will be weighted with the addition of bentonite gel, and if pressure conditions warrant, with barite

No chromate additives will be used in the mud system on Federal and/or Indian lands without prior BLM approval to ensure adequate protection of fresh aquifers.

No chemicals subject to reporting under SARA Title III in an amount equal to or greater than 10,000 pounds will be used, produced, stored, transported, or disposed of annually in association with the drilling, testing, or completing of this well. Furthermore, no extremely hazardous substances, as defined in 40 CFR 355, in threshold planning quantities, will be used, produced, stored, transported, or disposed of in association with the drilling, testing, or completing of this well.

Hazardous substances specifically listed by the EPA as a hazardous waste or demonstrating a characteristic of a hazardous waste will not be used in drilling, testing, or completion operations.

Newfield Production will **visually** monitor pit levels and flow from the well during drilling operations.

7. **AUXILIARY SAFETY EQUIPMENT TO BE USED:**

Auxiliary safety equipment will be a Kelly Cock, bit float, and a TIW valve with drill pipe threads.

8. **TESTING, LOGGING AND CORING PROGRAMS:**

The logging program will consist of a Dual Induction, Gamma Ray and Caliper log from TD to base of surface casing @ 300' +/-, and a Compensated Neutron-Formation Density Log from TD to 3500' +/- . A cement bond log will be run from PBTD to cement top. No drill stem testing or coring is planned for this well.

9. **ANTICIPATED ABNORMAL PRESSURE OR TEMPERATURE:**

No abnormal temperatures or pressures are anticipated. No hydrogen sulfide has been encountered or is known to exist from previous drilling in the area at this depth. Maximum anticipated

bottomhole pressure will approximately equal total depth in feet multiplied by a 0.433 psi/foot gradient.


10. **ANTICIPATED STARTING DATE AND DURATION OF THE OPERATIONS:**

It is anticipated that the drilling operations will commence the second quarter of 2012, and take approximately seven (7) days from spud to rig release.

T8S, R17E, S.L.B.&M.

NEWFIELD EXPLORATION COMPANY

WELL LOCATION, P-33-8-17, LOCATED
AS SHOWN IN THE NE 1/4 SE 1/4 OF
SECTION 32, T8S, R17E, S.L.B.&M.
DUCESNE COUNTY, UTAH.

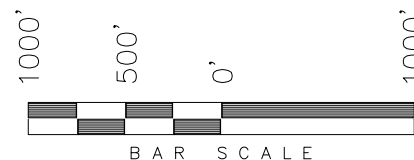

NOTES:

1. Well footages are measured at right angles to the Section Lines.
2. Bearings are based on Global Positioning Satellite observations.
3. The Center of Pattern footages are 1315' FSL & 50' FEL.

WELL LOCATION:
P-33-8-17

ELEV. EXIST. GRADED GROUND = 5192'

THIS IS TO CERTIFY THAT THE ABOVE PLAN WAS
PREPARED FROM FIELD NOTES OF ACTUAL SURVEYS
MADE BY ME OR UNDER MY SUPERVISION AND THAT
THE SAME ARE TRUE AND CORRECT TO THE BEST
OF MY KNOWLEDGE AND BELIEF.

STACY W.
STEWART

REGISTERED LAND SURVEY
REGISTRATION No. 0003737
STATE OF UTAH Q1-28-1

TRI STATE LAND SURVEYING & CONSULTING

180 NORTH VERNAL AVE. – VERNAL, UTAH 84078
(435) 781-2501

DATE SURVEYED:
01-17-11


SURVEYED BY: D.G.

DATE DRAWN:
01-28-11

DRAWN BY: M.W.

REVISÉ:

SCALE: 1" = 1000'

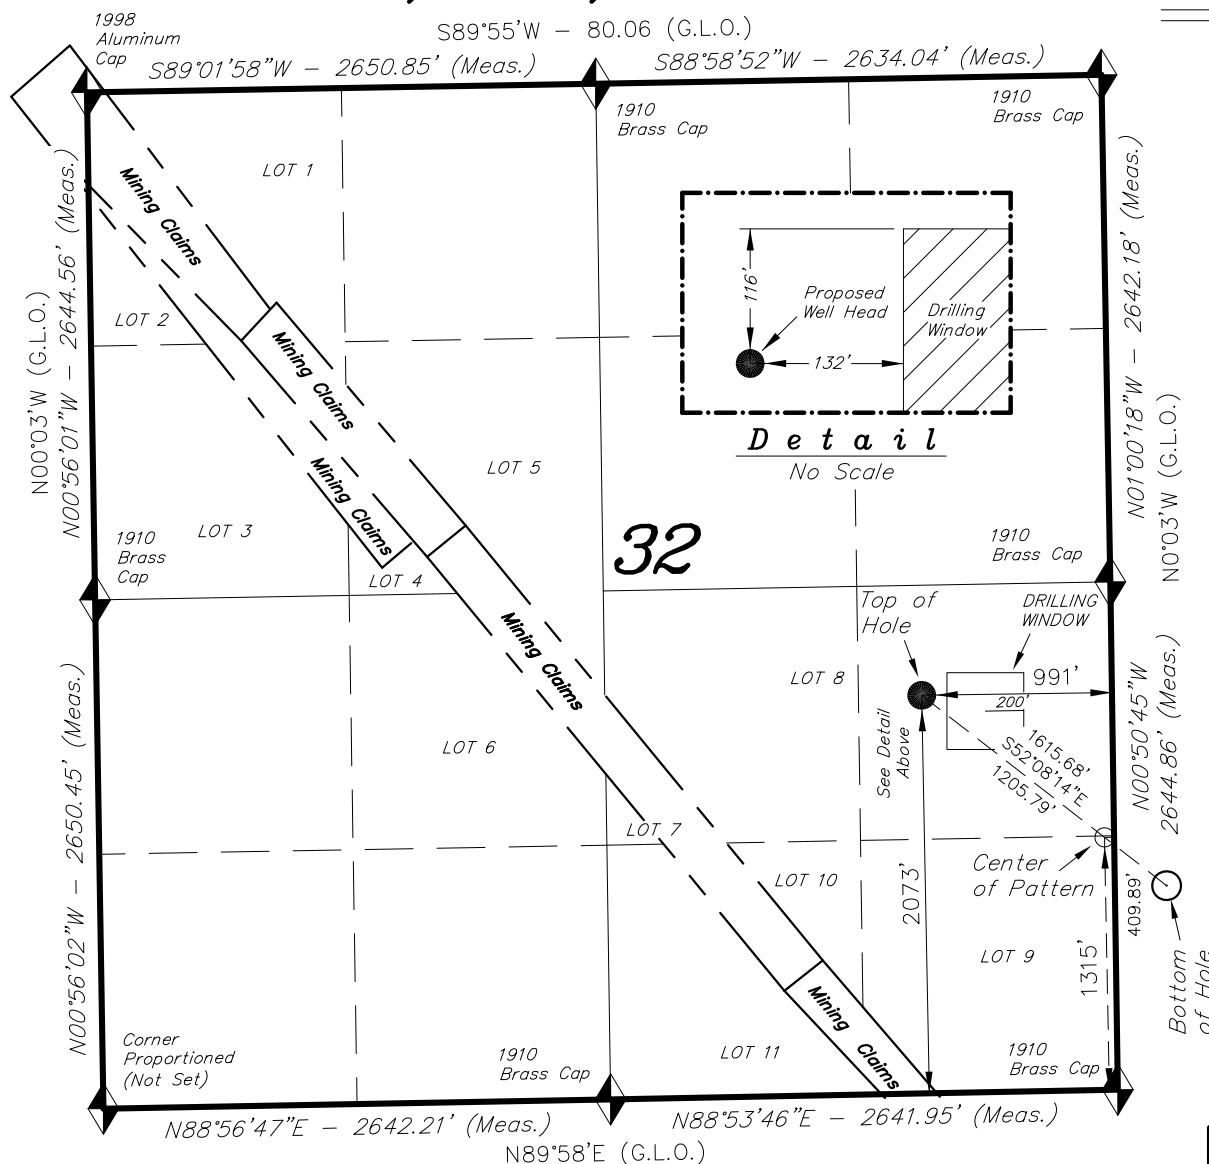

 = SECTION CORNERS LOCATED


BASIS OF ELEV; Elevations are based on
an N.G.S. OPUS Correction. LOCATION:
LAT. 40°04'09.56" LONG. 110°00'43.28"
(Tristate Aluminum Cap) Elev. 5281.57'

P-33-8-17
(Surface Location) NAD 83
LATITUDE = 40° 04' 22.27"
LONGITUDE = 110° 01' 28.23"


RECEIVED: October 26, 2011

T8S, R17E, S.L.B.&M.

NEWFIELD EXPLORATION COMPANY

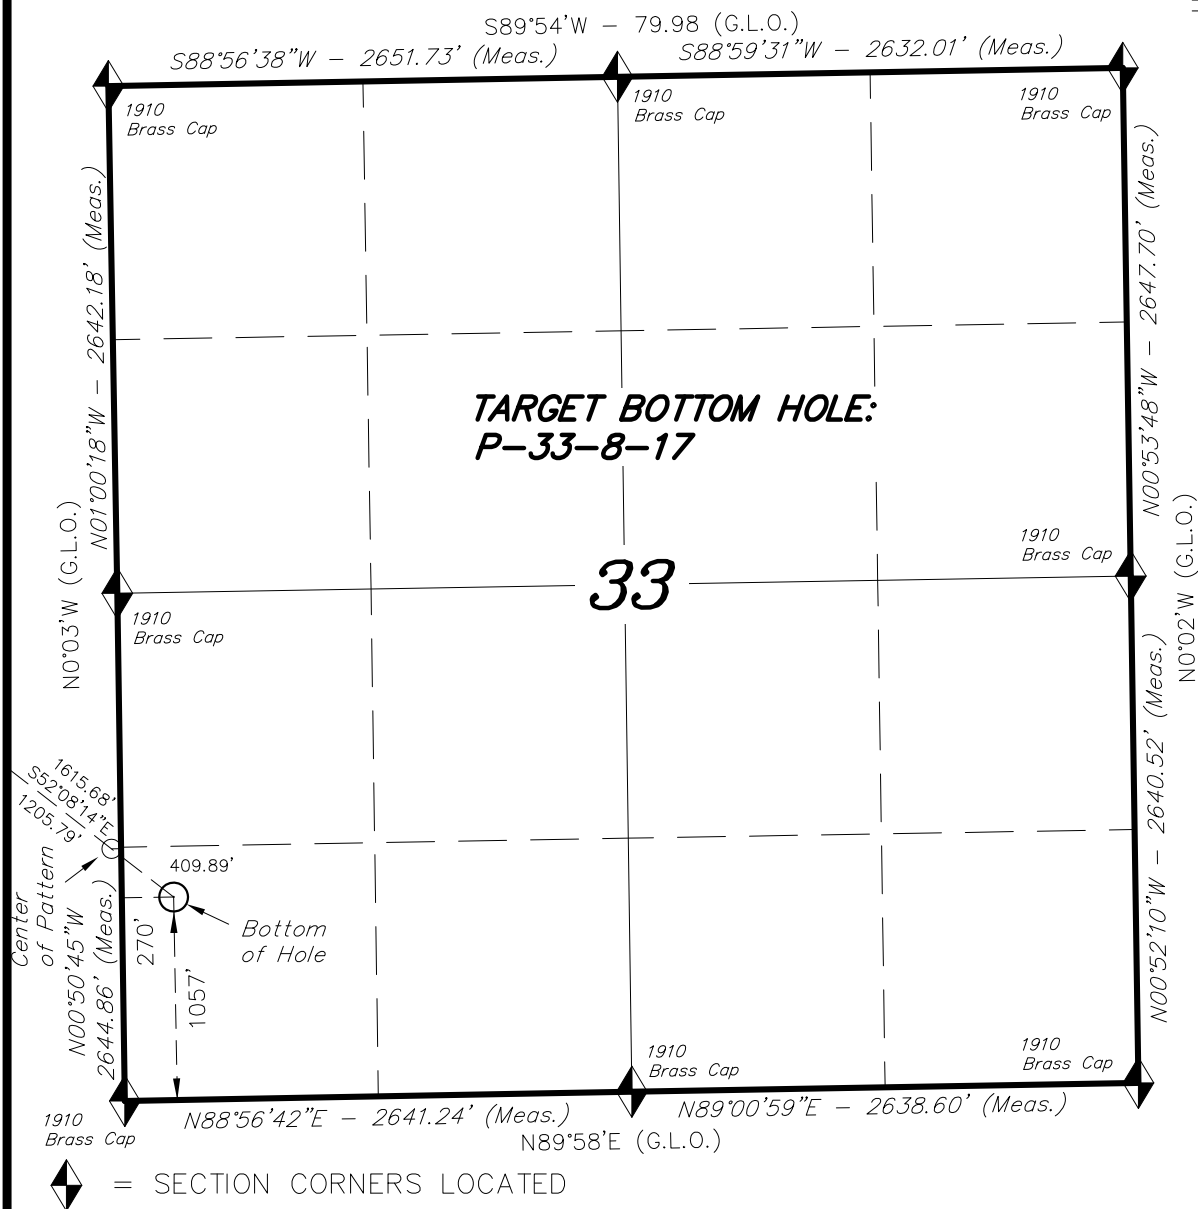

TARGET BOTTOM HOLE, P-33-8-17,
LOCATED AS SHOWN IN THE SW 1/4 SW
1/4 OF SECTION 33, T8S, R17E,
S.L.B.&M. DUCHESNE COUNTY, UTAH.

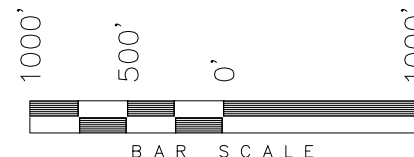

NOTES:

1. Well footages are measured at right angles to the Section Lines.
2. Bearings are based on Global Positioning Satellite observations.

THIS IS TO CERTIFY THAT THE ABOVE PLAT WAS
PREPARED FROM FIELD NOTES OF ACTUAL SURVEYS
MADE BY ME OR UNDER MY SUPERVISION AND THAT
THE SAME ARE TRUE AND CORRECT TO THE BEST
OF MY KNOWLEDGE AND BELIEF.

REGISTERED LAND SURVEYOR
STACY W. STEWART
REGISTERED LAND SURVEYOR
REGISTRATION No. 1189377
STATE OF UTAH


TRI STATE LAND SURVEYING & CONSULTING

180 NORTH VERNAL AVE. - VERNAL, UTAH 84078
(435) 781-2501

DATE SURVEYED: 01-17-11	SURVEYED BY: D.G.
DATE DRAWN: 01-28-11	DRAWN BY: M.W.
REVISED:	SCALE: 1" = 1000'

BASIS OF ELEV; Elevations are based on
an N.G.S. OPUS Correction. LOCATION:
LAT. 40°04'09.56" LONG. 110°00'43.28"
(Tristate Aluminum Cap) Elev. 5281.57'

RECEIVED: October 26, 2011

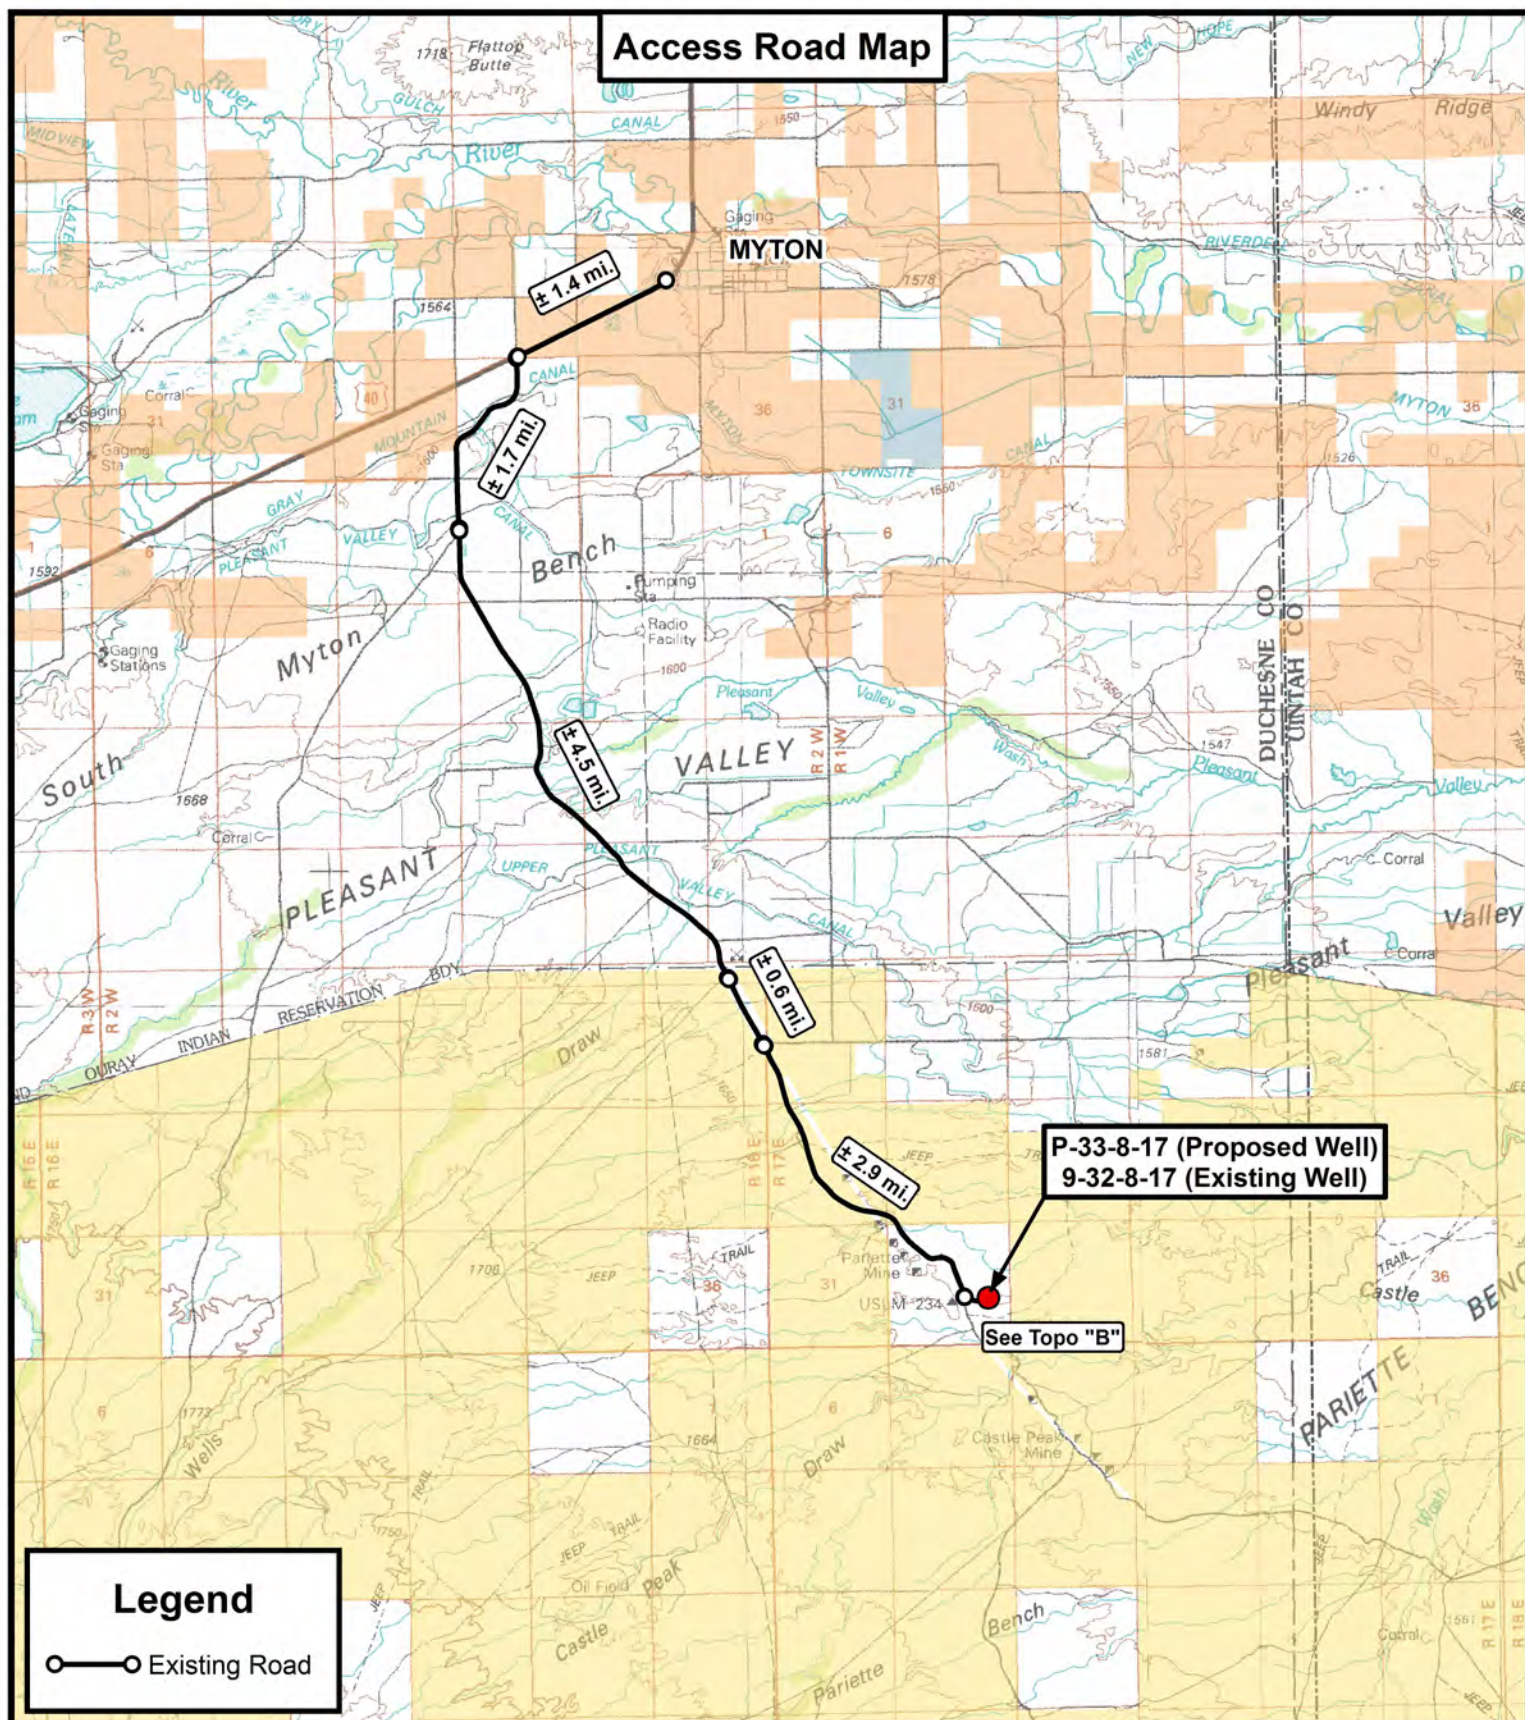

Tri State
Land Surveying, Inc.

180 NORTH VERNAL AVE. VERNAL, UTAH 84078

P: (435) 781-2501
 F: (435) 781-2518



NEWFIELD EXPLORATION COMPANY


P-33-8-17 (Proposed Well)
 9-32-8-17 (Existing Well)
 SEC. 32, T8S, R17E, S.L.B.&M.
 Duchesne County, UT.

DRAWN BY:	C.H.M.
DATE:	02-23-2011
SCALE:	1:100,000

TOPOGRAPHIC MAP

SHEET

A

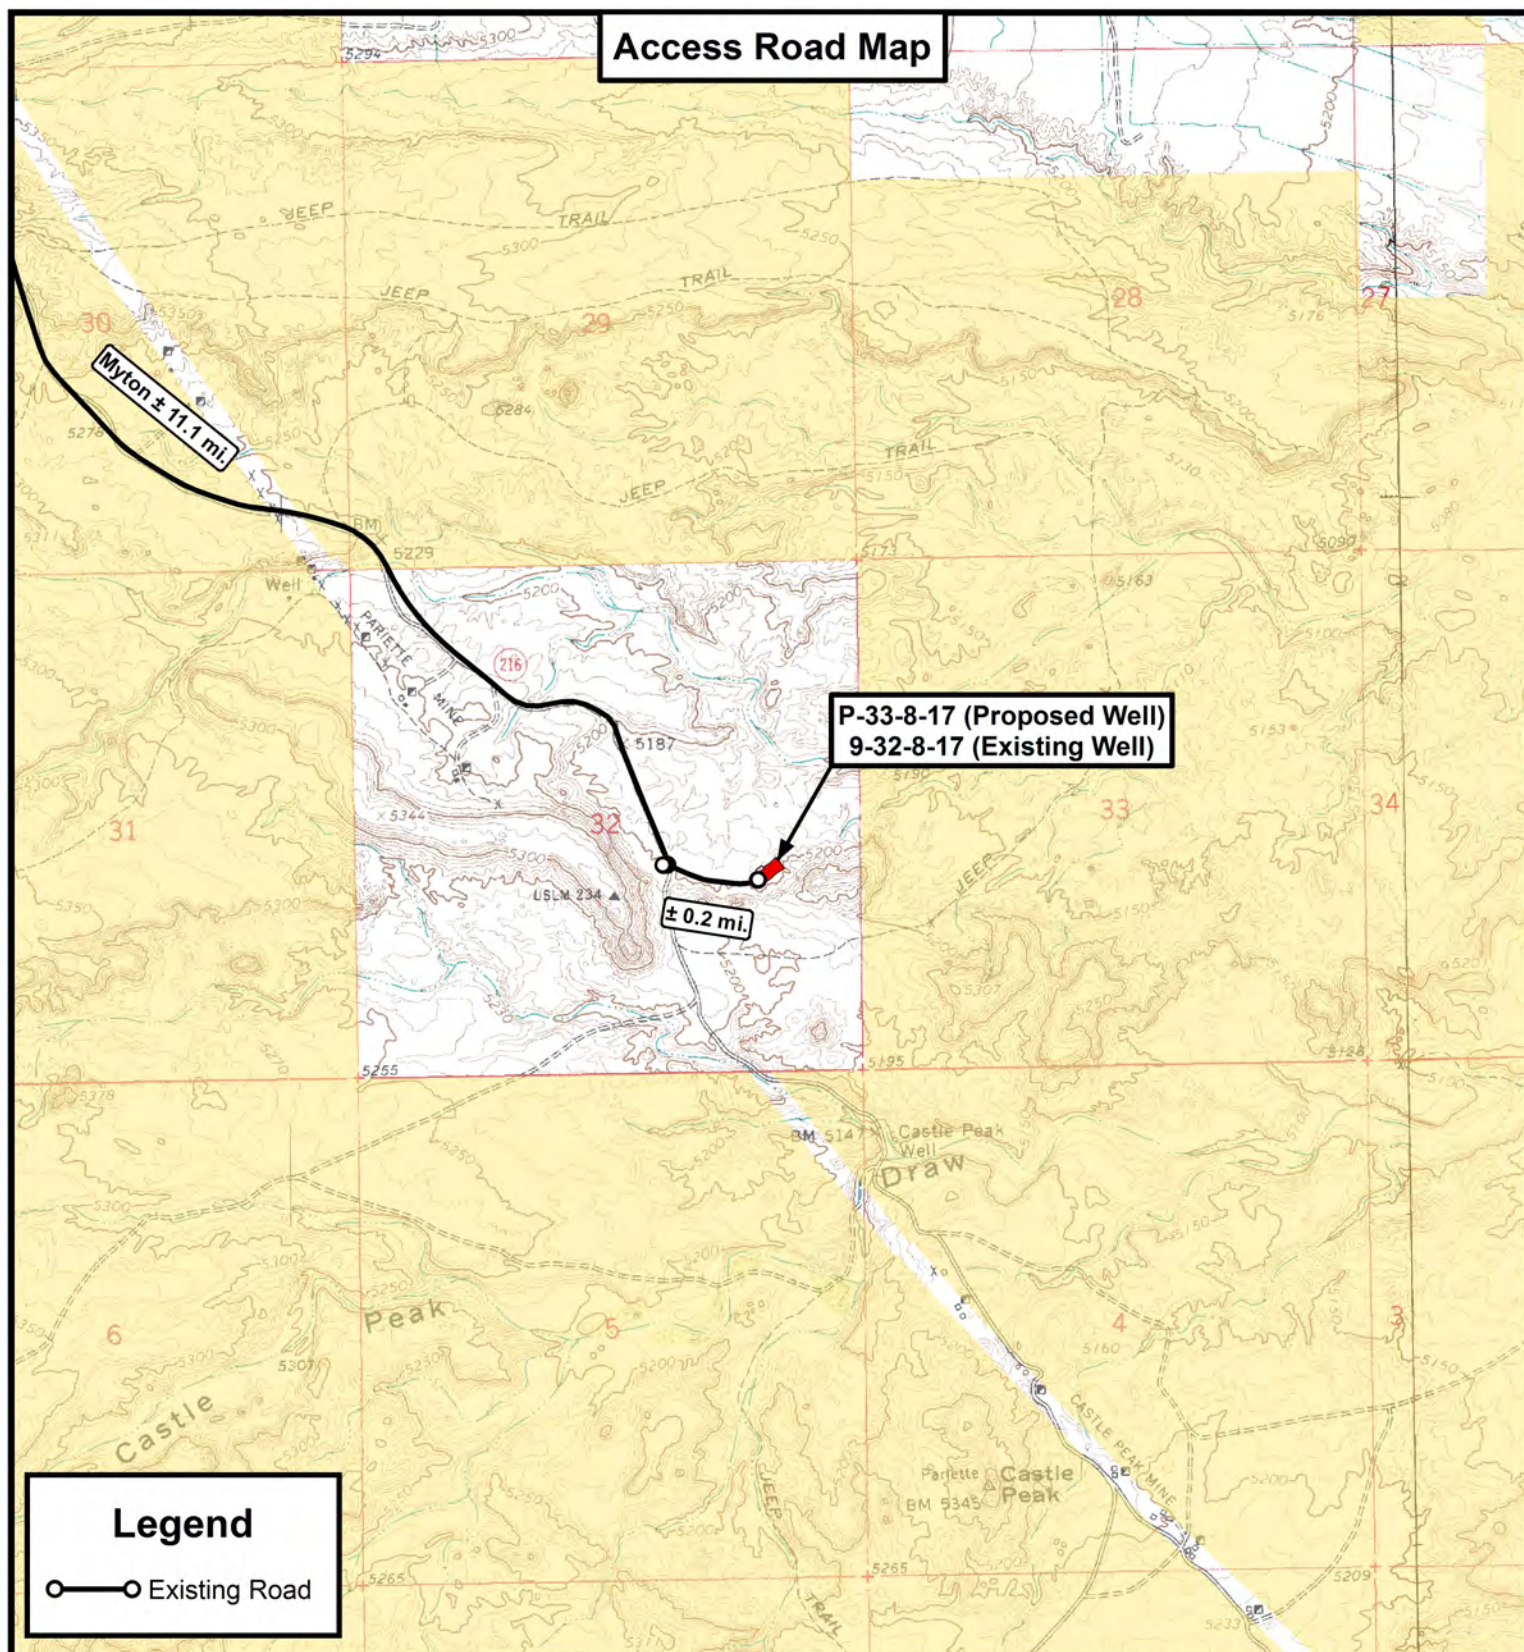

THE PARCEL INFORMATION SHOWN HAS NOT BEEN SURVEYED BY TRI-STATE LAND SURVEYING, INC. - TRI-STATE DOES NOT WARRANTY PROPERTY PARCEL DATA OR ANY ASSOCIATED INFORMATION. A PROPERTY SURVEY IS REQUIRED TO DETERMINE THE ACTUAL LOCATION OF PROPERTY LINES AND SHOW ACCURATE DISTANCES ACROSS PARCELS.



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P: (435) 781-2501
F: (435) 781-2518



NEWFIELD EXPLORATION COMPANY

P-33-8-17 (Proposed Well)
9-32-8-17 (Existing Well)
SEC. 32, T8S, R17E, S.L.B.&M.
Duchesne County, UT.


DRAWN BY:	C.H.M.
DATE:	02-23-2011
SCALE:	1" = 2,000'

TOPOGRAPHIC MAP

SHEET

B

Proposed Pipeline Map

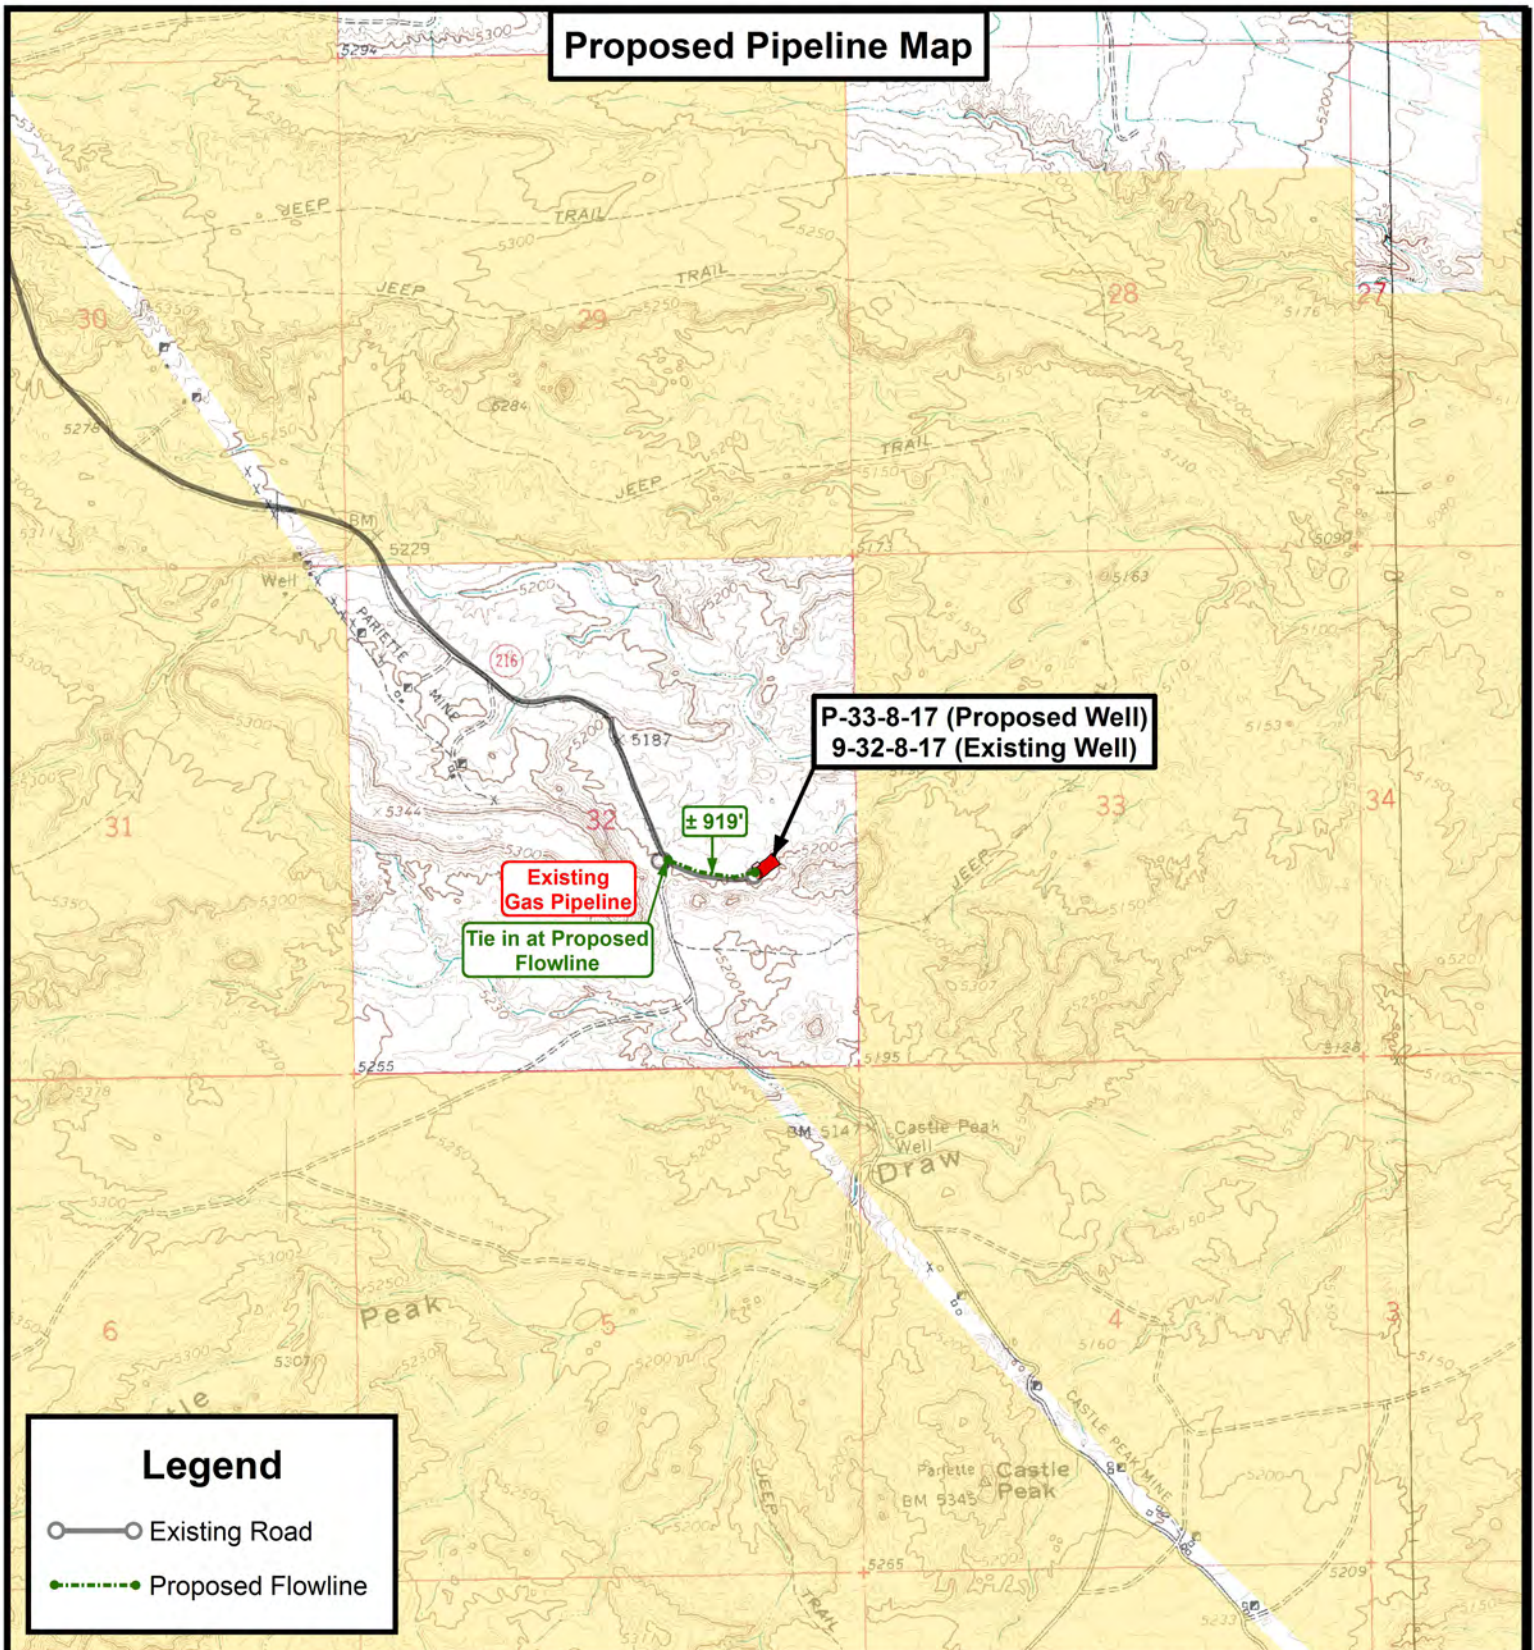

Legend

- Existing Road
- Proposed Flowline

THE PARCEL INFORMATION SHOWN HAS NOT BEEN SURVEYED BY TRI-STATE LAND SURVEYING, INC. - TRI-STATE DOES NOT WARRANTY PROPERTY PARCEL DATA OR ANY ASSOCIATED INFORMATION. A PROPERTY SURVEY IS REQUIRED TO DETERMINE THE ACTUAL LOCATION OF PROPERTY LINES AND SHOW ACCURATE DISTANCES ACROSS PARCELS.

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Land Surveying, Inc.
180 NORTH VERNAL AVE. VERNAL, UTAH 84078

P: (435) 781-2501
F: (435) 781-2518



NEWFIELD EXPLORATION COMPANY

P-33-8-17 (Proposed Well)
9-32-8-17 (Existing Well)
SEC. 32, T8S, R17E, S.L.B.&M.
Duchesne County, UT.


DRAWN BY: C.H.M.
DATE: 02-23-2011
SCALE: 1" = 2,000'

TOPOGRAPHIC MAP

SHEET
C

Exhibit "B" Map

P-33-8-17 (Proposed Well)
9-32-8-17 (Existing Well)

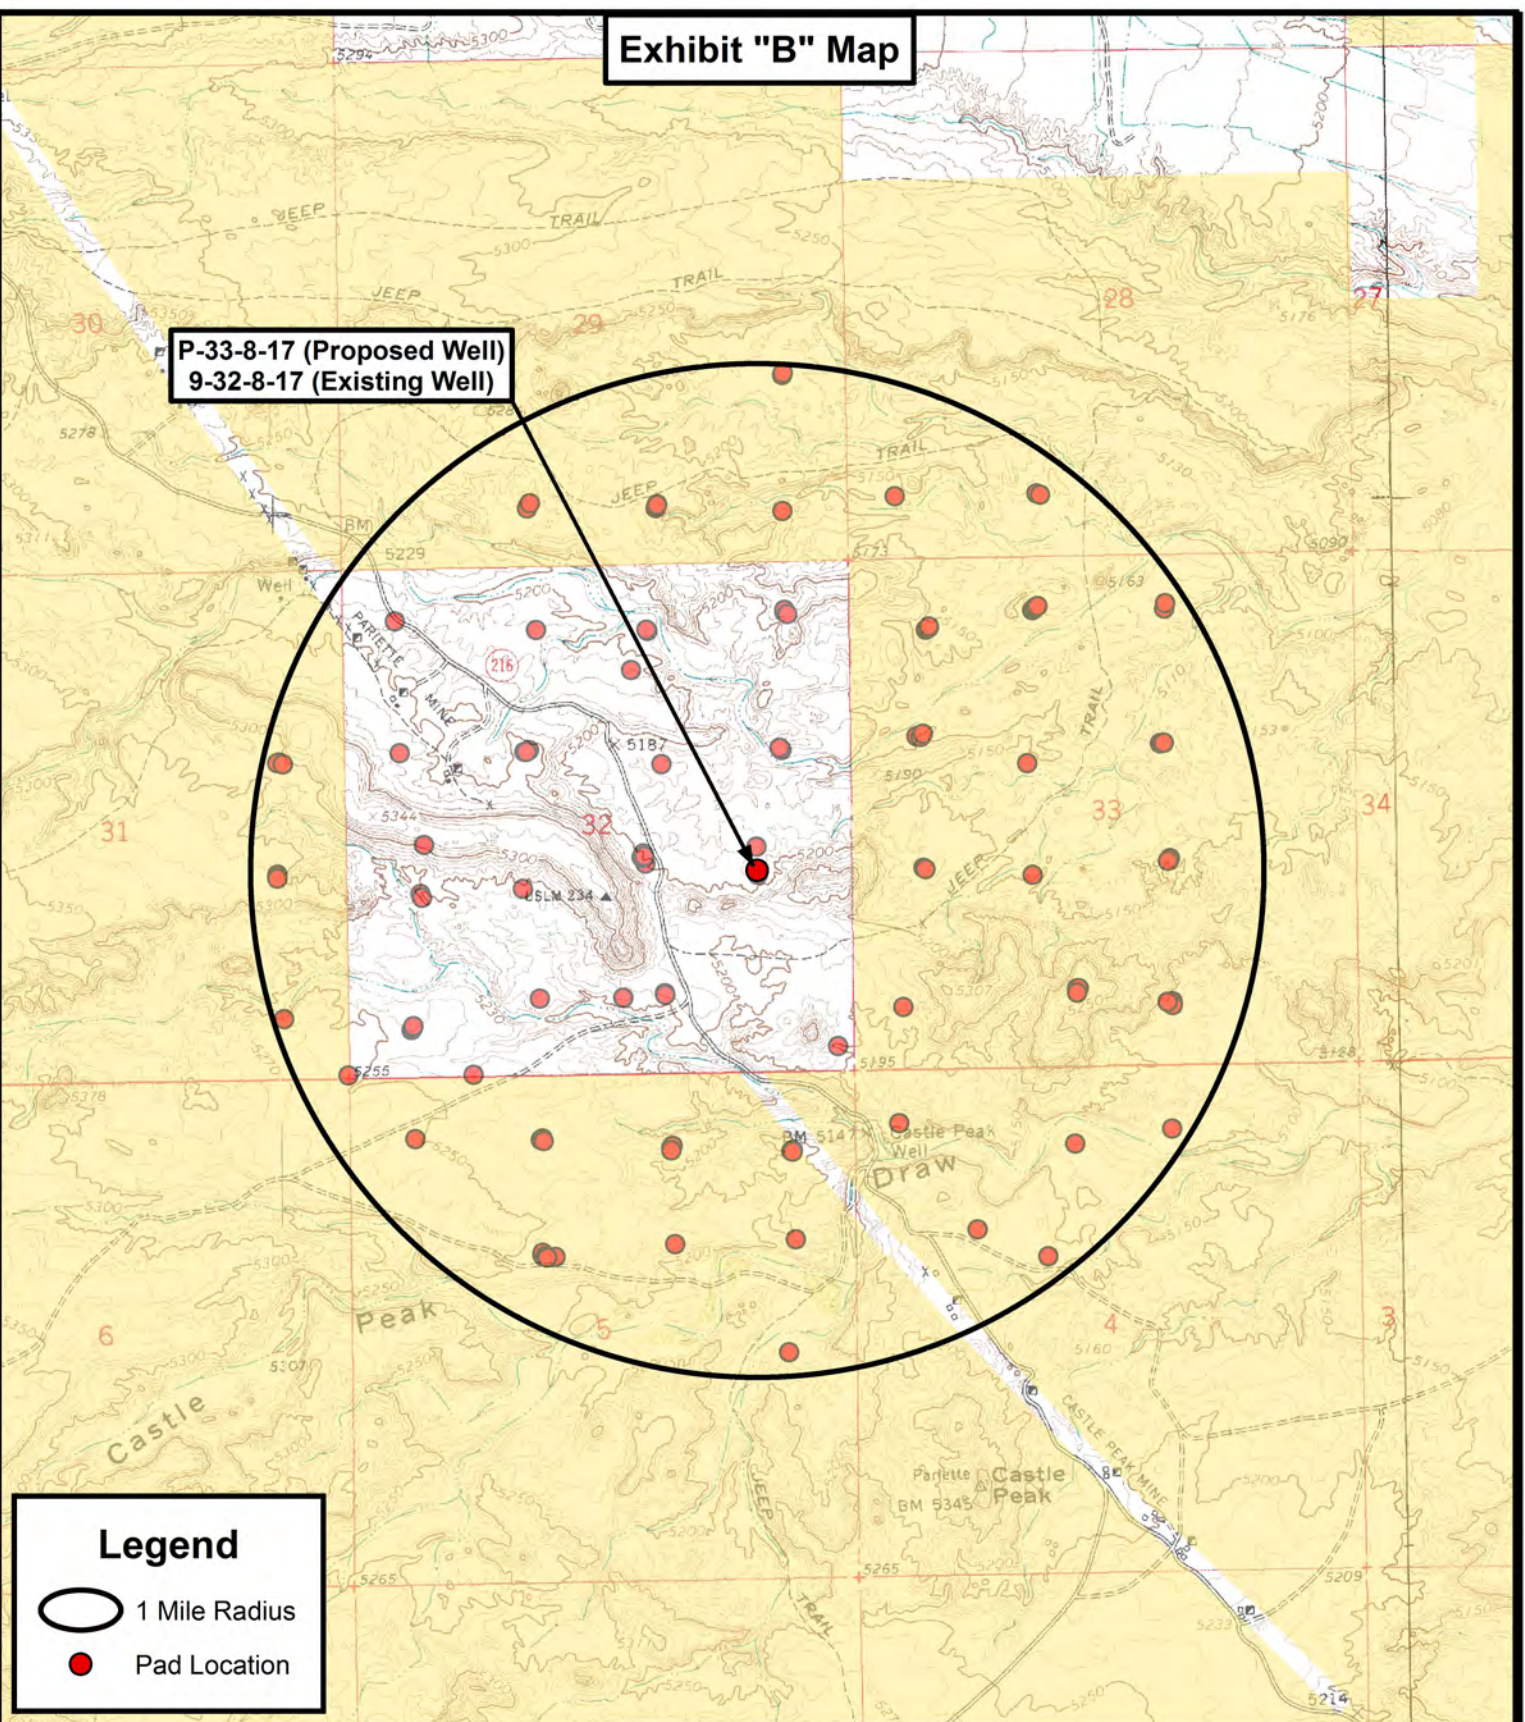**Legend**

- 1 Mile Radius
 ● Pad Location

Tri State
Land Surveying, Inc.
 180 NORTH VERNAL AVE. VERNAL, UTAH 84078

P: (435) 781-2501
 F: (435) 781-2518

**NEWFIELD EXPLORATION COMPANY**

P-33-8-17 (Proposed Well)
9-32-8-17 (Existing Well)
SEC. 32, T8S, R17E, S.L.B.&M.
Duchesne County, UT.

DRAWN BY: C.H.M.
 DATE: 2-23-2011
 SCALE: 1" = 2,000'

TOPOGRAPHIC MAP

SHEET

D



NEWFIELD EXPLORATION

**USGS Myton SW (UT)
SECTION 32 T8S, R17E
P-33-8-17**

Wellbore #1

Plan: Design #1

Standard Planning Report

17 October, 2011



Payzone Directional

Planning Report

Database:	EDM 2003.21 Single User Db	Local Co-ordinate Reference:	Well P-33-8-17
Company:	NEWFIELD EXPLORATION	TVD Reference:	P-33-8-17 @ 5204.0ft (Newfield Rig)
Project:	USGS Myton SW (UT)	MD Reference:	P-33-8-17 @ 5204.0ft (Newfield Rig)
Site:	SECTION 32 T8S, R17E	North Reference:	True
Well:	P-33-8-17	Survey Calculation Method:	Minimum Curvature
Wellbore:	Wellbore #1		
Design:	Design #1		

Project	USGS Myton SW (UT), DUCHESNE COUNTY, UT, USA		
Map System:	US State Plane 1983	System Datum:	Mean Sea Level
Geo Datum:	North American Datum 1983		
Map Zone:	Utah Central Zone		

Site	SECTION 32 T8S, R17E, SEC 32 T8S, R17E			
Site Position:		Northing:	7,199,243.00 ft	Latitude: 40° 4' 28.149 N
From:	Lat/Long	Easting:	2,052,198.00 ft	Longitude: 110° 1' 42.260 W
Position Uncertainty:	0.0 ft	Slot Radius:	"	Grid Convergence: 0.94 °

Well	P-33-8-17, SHL LAT: 40 04 22.27 LONG: -110 01 28.23					
Well Position	+N/-S	-594.9 ft	Northing:	7,198,666.13 ft	Latitude:	40° 4' 22.270 N
	+E/-W	1,090.6 ft	Easting:	2,053,298.25 ft	Longitude:	110° 1' 28.230 W
Position Uncertainty		0.0 ft	Wellhead Elevation:	5,204.0 ft	Ground Level:	5,192.0 ft

Wellbore	Wellbore #1				
Magnetics	Model Name	Sample Date	Declination (°)	Dip Angle (°)	Field Strength (nT)
	IGRF2010	1/27/2011	11.35	65.84	52,331

Design	Design #1			
Audit Notes:				
Version:	Phase:	PROTOTYPE	Tie On Depth:	0.0
Vertical Section:	Depth From (TVD) (ft)	+N/-S (ft)	+E/-W (ft)	Direction (°)
	4,950.0	0.0	0.0	127.86

Plan Sections										
Measured Depth (ft)	Inclination (°)	Azimuth (°)	Vertical Depth (ft)	+N/-S (ft)	+E/-W (ft)	Dogleg Rate (°/100ft)	Build Rate (°/100ft)	Turn Rate (°/100ft)	TFO (°)	Target
0.0	0.00	0.00	0.0	0.0	0.0	0.00	0.00	0.00	0.00	
600.0	0.00	0.00	600.0	0.0	0.0	0.00	0.00	0.00	0.00	
1,788.0	17.82	127.86	1,768.9	-112.5	144.7	1.50	1.50	0.00	127.86	
5,129.4	17.82	127.86	4,950.0	-740.0	952.0	0.00	0.00	0.00	0.00	P-33-8-17 TGT
6,468.6	17.82	127.86	6,225.0	-991.6	1,275.6	0.00	0.00	0.00	0.00	



Payzone Directional Planning Report

Database:	EDM 2003.21 Single User Db	Local Co-ordinate Reference:	Well P-33-8-17
Company:	NEWFIELD EXPLORATION	TVD Reference:	P-33-8-17 @ 5204.0ft (Newfield Rig)
Project:	USGS Myton SW (UT)	MD Reference:	P-33-8-17 @ 5204.0ft (Newfield Rig)
Site:	SECTION 32 T8S, R17E	North Reference:	True
Well:	P-33-8-17	Survey Calculation Method:	Minimum Curvature
Wellbore:	Wellbore #1		
Design:	Design #1		

Planned Survey									
Measured Depth (ft)	Inclination (°)	Azimuth (°)	Vertical Depth (ft)	+N/-S (ft)	+E/-W (ft)	Vertical Section (ft)	Dogleg Rate (°/100ft)	Build Rate (°/100ft)	Turn Rate (°/100ft)
0.0	0.00	0.00	0.0	0.0	0.0	0.0	0.00	0.00	0.00
100.0	0.00	0.00	100.0	0.0	0.0	0.0	0.00	0.00	0.00
200.0	0.00	0.00	200.0	0.0	0.0	0.0	0.00	0.00	0.00
300.0	0.00	0.00	300.0	0.0	0.0	0.0	0.00	0.00	0.00
400.0	0.00	0.00	400.0	0.0	0.0	0.0	0.00	0.00	0.00
500.0	0.00	0.00	500.0	0.0	0.0	0.0	0.00	0.00	0.00
600.0	0.00	0.00	600.0	0.0	0.0	0.0	0.00	0.00	0.00
700.0	1.50	127.86	700.0	-0.8	1.0	1.3	1.50	1.50	0.00
800.0	3.00	127.86	799.9	-3.2	4.1	5.2	1.50	1.50	0.00
900.0	4.50	127.86	899.7	-7.2	9.3	11.8	1.50	1.50	0.00
1,000.0	6.00	127.86	999.3	-12.8	16.5	20.9	1.50	1.50	0.00
1,100.0	7.50	127.86	1,098.6	-20.1	25.8	32.7	1.50	1.50	0.00
1,200.0	9.00	127.86	1,197.5	-28.9	37.1	47.0	1.50	1.50	0.00
1,300.0	10.50	127.86	1,296.1	-39.3	50.5	64.0	1.50	1.50	0.00
1,400.0	12.00	127.86	1,394.2	-51.2	65.9	83.5	1.50	1.50	0.00
1,500.0	13.50	127.86	1,491.7	-64.8	83.3	105.5	1.50	1.50	0.00
1,600.0	15.00	127.86	1,588.6	-79.9	102.8	130.2	1.50	1.50	0.00
1,700.0	16.50	127.86	1,684.9	-96.5	124.2	157.3	1.50	1.50	0.00
1,788.0	17.82	127.86	1,768.9	-112.5	144.7	183.3	1.50	1.50	0.00
1,800.0	17.82	127.86	1,780.4	-114.7	147.6	186.9	0.00	0.00	0.00
1,900.0	17.82	127.86	1,875.6	-133.5	171.7	217.5	0.00	0.00	0.00
2,000.0	17.82	127.86	1,970.8	-152.3	195.9	248.1	0.00	0.00	0.00
2,100.0	17.82	127.86	2,066.0	-171.1	220.1	278.7	0.00	0.00	0.00
2,200.0	17.82	127.86	2,161.2	-189.9	244.2	309.3	0.00	0.00	0.00
2,300.0	17.82	127.86	2,256.4	-208.6	268.4	339.9	0.00	0.00	0.00
2,400.0	17.82	127.86	2,351.6	-227.4	292.6	370.5	0.00	0.00	0.00
2,500.0	17.82	127.86	2,446.8	-246.2	316.7	401.1	0.00	0.00	0.00
2,600.0	17.82	127.86	2,542.0	-265.0	340.9	431.7	0.00	0.00	0.00
2,700.0	17.82	127.86	2,637.2	-283.8	365.0	462.3	0.00	0.00	0.00
2,800.0	17.82	127.86	2,732.4	-302.5	389.2	493.0	0.00	0.00	0.00
2,900.0	17.82	127.86	2,827.6	-321.3	413.4	523.6	0.00	0.00	0.00
3,000.0	17.82	127.86	2,922.8	-340.1	437.5	554.2	0.00	0.00	0.00
3,100.0	17.82	127.86	3,018.0	-358.9	461.7	584.8	0.00	0.00	0.00
3,200.0	17.82	127.86	3,113.2	-377.7	485.8	615.4	0.00	0.00	0.00
3,300.0	17.82	127.86	3,208.4	-396.4	510.0	646.0	0.00	0.00	0.00
3,400.0	17.82	127.86	3,303.6	-415.2	534.2	676.6	0.00	0.00	0.00
3,500.0	17.82	127.86	3,398.8	-434.0	558.3	707.2	0.00	0.00	0.00
3,600.0	17.82	127.86	3,494.0	-452.8	582.5	737.8	0.00	0.00	0.00
3,700.0	17.82	127.86	3,589.2	-471.6	606.6	768.4	0.00	0.00	0.00
3,800.0	17.82	127.86	3,684.4	-490.4	630.8	799.0	0.00	0.00	0.00
3,900.0	17.82	127.86	3,779.6	-509.1	655.0	829.6	0.00	0.00	0.00
4,000.0	17.82	127.86	3,874.8	-527.9	679.1	860.2	0.00	0.00	0.00
4,100.0	17.82	127.86	3,970.0	-546.7	703.3	890.8	0.00	0.00	0.00
4,200.0	17.82	127.86	4,065.2	-565.5	727.4	921.4	0.00	0.00	0.00
4,300.0	17.82	127.86	4,160.4	-584.3	751.6	952.0	0.00	0.00	0.00
4,400.0	17.82	127.86	4,255.6	-603.0	775.8	982.6	0.00	0.00	0.00
4,500.0	17.82	127.86	4,350.8	-621.8	799.9	1,013.2	0.00	0.00	0.00
4,600.0	17.82	127.86	4,446.0	-640.6	824.1	1,043.8	0.00	0.00	0.00
4,700.0	17.82	127.86	4,541.2	-659.4	848.2	1,074.4	0.00	0.00	0.00
4,800.0	17.82	127.86	4,636.4	-678.2	872.4	1,105.0	0.00	0.00	0.00
4,900.0	17.82	127.86	4,731.6	-696.9	896.6	1,135.6	0.00	0.00	0.00
5,000.0	17.82	127.86	4,826.8	-715.7	920.7	1,166.2	0.00	0.00	0.00
5,100.0	17.82	127.86	4,922.0	-734.5	944.9	1,196.8	0.00	0.00	0.00
5,129.4	17.82	127.86	4,950.0	-740.0	952.0	1,205.8	0.00	0.00	0.00



Payzone Directional

Planning Report

Database:	EDM 2003.21 Single User Db	Local Co-ordinate Reference:	Well P-33-8-17
Company:	NEWFIELD EXPLORATION	TVD Reference:	P-33-8-17 @ 5204.0ft (Newfield Rig)
Project:	USGS Myton SW (UT)	MD Reference:	P-33-8-17 @ 5204.0ft (Newfield Rig)
Site:	SECTION 32 T8S, R17E	North Reference:	True
Well:	P-33-8-17	Survey Calculation Method:	Minimum Curvature
Wellbore:	Wellbore #1		
Design:	Design #1		

Planned Survey									
Measured Depth (ft)	Inclination (°)	Azimuth (°)	Vertical Depth (ft)	+N/-S (ft)	+E/-W (ft)	Vertical Section (ft)	Dogleg Rate (°/100ft)	Build Rate (°/100ft)	Turn Rate (°/100ft)
5,200.0	17.82	127.86	5,017.2	-753.3	969.1	1,227.4	0.00	0.00	0.00
5,300.0	17.82	127.86	5,112.5	-772.1	993.2	1,258.0	0.00	0.00	0.00
5,400.0	17.82	127.86	5,207.7	-790.9	1,017.4	1,288.6	0.00	0.00	0.00
5,500.0	17.82	127.86	5,302.9	-809.6	1,041.5	1,319.2	0.00	0.00	0.00
5,600.0	17.82	127.86	5,398.1	-828.4	1,065.7	1,349.8	0.00	0.00	0.00
5,700.0	17.82	127.86	5,493.3	-847.2	1,089.9	1,380.4	0.00	0.00	0.00
5,800.0	17.82	127.86	5,588.5	-866.0	1,114.0	1,411.0	0.00	0.00	0.00
5,900.0	17.82	127.86	5,683.7	-884.8	1,138.2	1,441.6	0.00	0.00	0.00
6,000.0	17.82	127.86	5,778.9	-903.5	1,162.3	1,472.2	0.00	0.00	0.00
6,100.0	17.82	127.86	5,874.1	-922.3	1,186.5	1,502.8	0.00	0.00	0.00
6,200.0	17.82	127.86	5,969.3	-941.1	1,210.7	1,533.4	0.00	0.00	0.00
6,300.0	17.82	127.86	6,064.5	-959.9	1,234.8	1,564.0	0.00	0.00	0.00
6,400.0	17.82	127.86	6,159.7	-978.7	1,259.0	1,594.6	0.00	0.00	0.00
6,468.6	17.82	127.86	6,225.0	-991.6	1,275.6	1,615.6	0.00	0.00	0.00





Project: USGS Myton SW (UT)
 Site: SECTION 32 T8S, R17E
 Well: P-33-8-17
 Wellbore: Wellbore #1
 Design: Design #1

KOP @ 200'
 DOGLEG RATE 1.5 DEG /100
 TARGET RADIUS 50'



Azimuths to True North
 Magnetic North: 11.35°

Magnetic Field
 Strength: 52331.1snT
 Dip Angle: 65.84°
 Date: 1/27/2011
 Model: IGRF2010

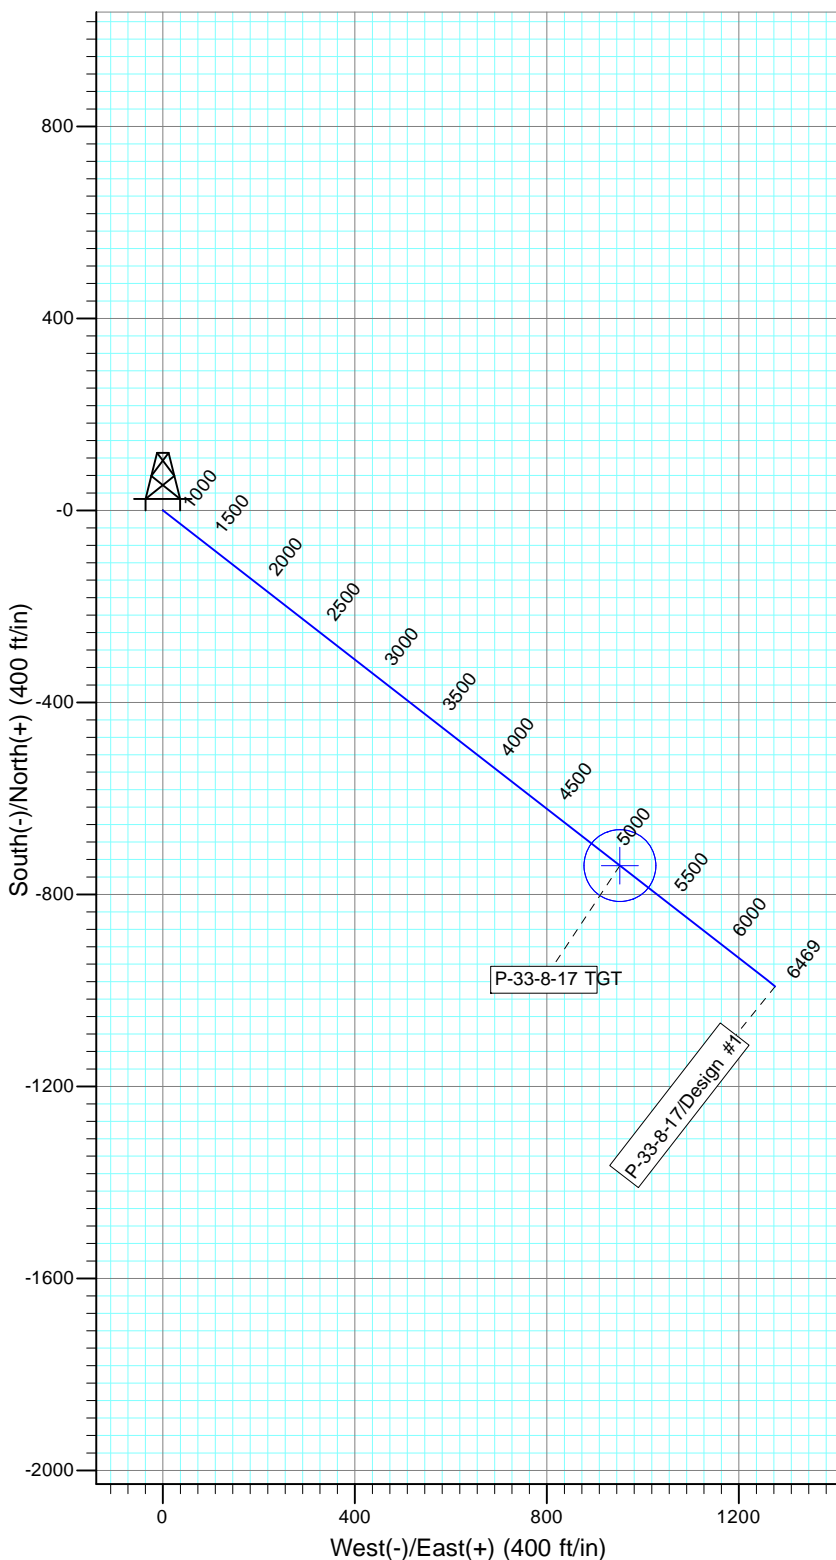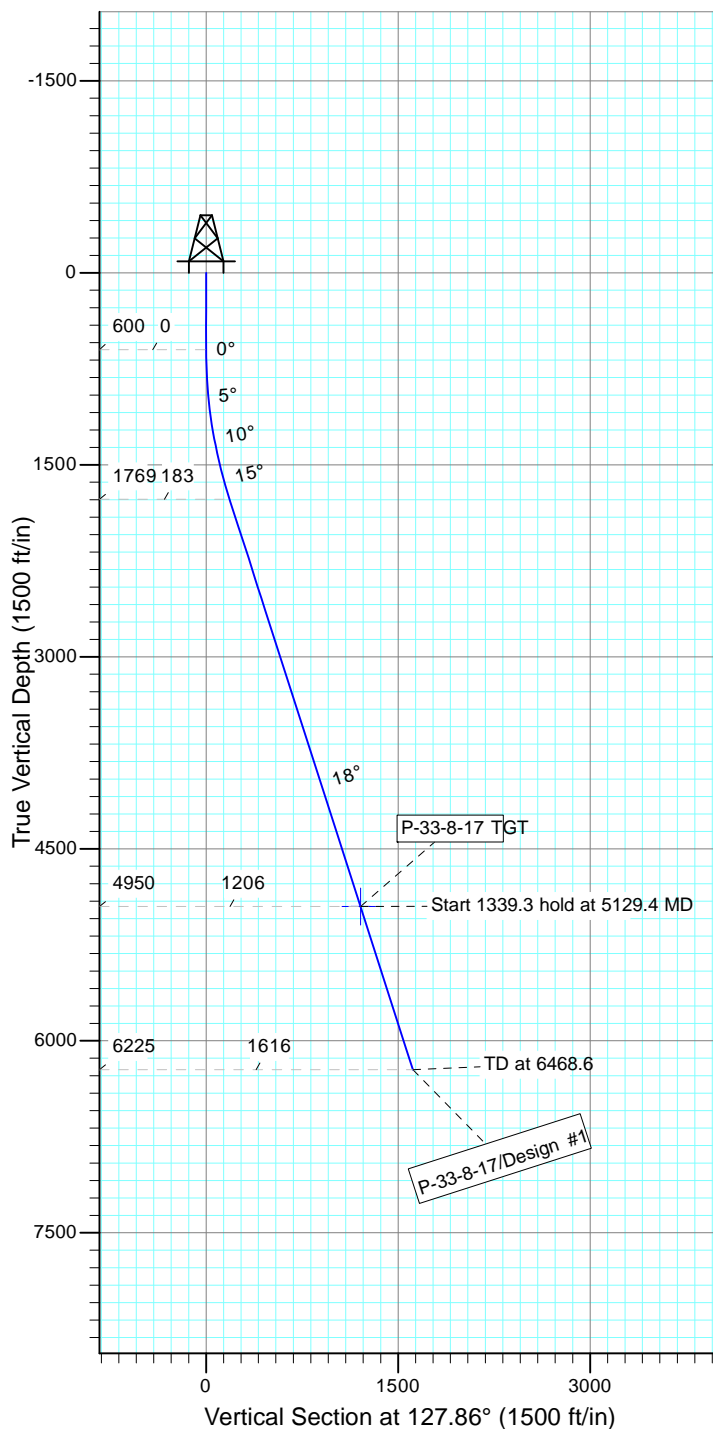

WELLBORE TARGET DETAILS

Name	TVD	+N/-S	+E/-W	Shape
P-33-8-17 TGT	5129.4	-740.0	952.0	Circle (Radius: 75.0)

SECTION DETAILS

Sec	MD	Inc	Azi	TVD	+N/-S	+E/-W	DLeg	TFace	VSec	Target
1	0.0	0.00	0.00	0.0	0.0	0.0	0.00	0.00	0.0	
2	600.0	0.00	0.00	600.0	0.0	0.0	0.00	0.00	0.0	
3	1788.0	17.82	127.86	1768.9	-112.5	144.7	1.50	127.86	183.3	
4	5129.4	17.82	127.86	4950.0	-740.0	952.0	0.00	0.00	1205.8	P-33-8-17 TGT
5	56468.6	17.82	127.86	6225.0	-991.6	1275.6	0.00	0.00	1615.6	



**NEWFIELD PRODUCTION COMPANY
GMBU P-33-8-17
AT SURFACE: NE/SE SECTION 32, T8S, R17E
DUCHESNE COUNTY, UTAH**

ONSHORE ORDER NO. 1

MULTI-POINT SURFACE USE & OPERATIONS PLAN

1. EXISTING ROADS

See attached Topographic Map "A"

To reach Newfield Production Company well location site GMBU P-33-8-17 located in the NE 1/4 SE 1/4 Section 32, T8S, R17E, Duchesne County, Utah:

Proceed southwesterly out of Myton, Utah along Highway 40 – 1.4 miles \pm to the junction of this highway and UT State Hwy 53; proceed in a southeasterly direction – 9.7 miles \pm to it's junction with an existing road to the east; proceed in a southeasterly direction – 0.2 miles to the existing 9-32-8-17 well location.

The aforementioned dirt oil field service roads and other roads in the vicinity are constructed out of existing native materials that are prevalent to the existing area they are located in and range from clays to a sandy-clay shale material.

The roads for access during the drilling, completion and production phase will be maintained at the standards required by the State of Utah, or other controlling agencies. This maintenance will consist of some minor grader work for smoothing road surfaces and for snow removal. Any necessary fill material for repair will be purchase and hauled from private sources.

2. PLANNED ACCESS ROAD

There is no proposed access road for this location. The proposed well will be drilled directionally off of the existing 9-32-8-17 well pad. See attached **Topographic Map "B"**.

There will be **no** culverts required along this access road. There will be barrow ditches and turnouts as needed along this road.

There are no fences encountered along this proposed road. There will be no new gates or cattle guards required.

All construction material for this access road will be borrowed material accumulated during construction of the access road.

3. LOCATION OF EXISTING WELLS

Refer to Exhibit "B".

4. LOCATION OF EXISTING AND/OR PROPOSED FACILITIES

There are no existing facilities that will be used by this well.

It is anticipated that this well will be a producing oil well.

Upon construction of a tank battery, the well pad will be surrounded by a dike of sufficient capacity to contain at minimum 110% of the largest tank volume within the facility battery.

Tank batteries will be built to State specifications.

All permanent (on site for six (6) months or longer) structures, constructed or installed (including pumping units), will be painted a flat, non-reflective, earth tone color to match one of the standard environmental colors, as determined by the Rocky Mountain Five State Interagency Committee. All facilities will be painted within six months of installation.

5. **LOCATION AND TYPE OF WATER SUPPLY**

Newfield Production will transport water by truck from nearest water source as determined by a Newfield representative for the purpose of drilling the above mentioned well. The available water sources are as follows:

Johnson Water District
Water Right : 43-10136

Maurice Harvey Pond
Water Right: 47-1358

Neil Moon Pond
Water Right: 43-11787

Newfield Collector Well
Water Right: 47-1817 (A30414DVA, contracted with the Duchesne County Conservancy District).

There will be no water well drilled at this site.

6. **SOURCE OF CONSTRUCTION MATERIALS**

All construction material for this location shall be borrowed material accumulated during construction of the location site and access road.

A mineral material application is not required for this location.

7. **METHODS FOR HANDLING WASTE DISPOSAL**

A small reserve pit (90' x 40' x 8' deep, or less) will be constructed from native soil and clay materials. The reserve pit will receive the processed drill cutting (wet sand, shale & rock) removed from the wellbore. Any drilling fluids, which do accumulate in the pit as a result of shale-shaker carryover, cleaning of the sand trap, etc., will be promptly reclaimed. All drilling fluids will be fresh water based, typically containing Total Dissolved Solids of less than 3000 PPM. No potassium chloride, chromates, trash, debris, nor any other substance deemed hazardous will be placed in this pit. Therefore, it is proposed that no synthetic liner be required in the reserve pit. However, if upon constructing the pit there is insufficient fine clay and silt present, a liner will be used for the purpose of reducing water loss through percolation.

Newfield requests approval that a flare pit not be constructed or utilized on this location.

A portable toilet will be provided for human waste.

A trash basket will be provided for garbage (trash) and hauled away to an approved disposal site at the completion of the drilling activities.

8. **ANCILLARY FACILITIES**

There are no ancillary facilities planned for at the present time and none foreseen in the near future.

9. **WELL SITE LAYOUT**

See attached Location Layout Sheet.

Fencing Requirements

All pits will be fenced according to the following minimum standards:

- a) A 39-inch net wire shall be used with at least one strand of barbed wire on top of the net.
- b) The net wire shall be no more than two (2) inches above the ground. The barbed wire shall be three (3) inches above the net wire. Total height of the fence shall be at least forty-two (42) inches.
- c) Corner posts shall be centered and/or braced in such a manner to keep tight at all times
- d) Standard steel, wood or pipe posts shall be used between the corner braces. Maximum distance between any two posts shall be no greater than sixteen (16) feet.
- e) All wire shall be stretched, by using a stretching device, before it is attached to the corner posts.

The reserve pit fencing will be on three (3) sides during drilling operations and on the fourth side when the rig moves off location. Pits will be fenced and maintained until cleanup.

Existing fences to be crossed by the access road will be braced and tied off before cutting so as to prevent slacking in the wire. The opening shall be closed temporarily as necessary during construction to prevent the escape of livestock, and upon completion of construction the fence shall be repaired to BLM specifications.

10. **PLANS FOR RESTORATION OF SURFACE:**

- a) Producing Location

Immediately upon well completion, the location and surrounding area will be cleared of all unused tubing, equipment, debris, material, trash and junk not required for production.

The reserve pit and that portion of the location not needed for production facilities/operations will be recontoured to the approximated natural contours. Weather permitting, the reserve pit will be reclaimed within one hundred twenty (120) days from the date of well completion. Before any dirt work takes place, the reserve pit must have all fluids and hydrocarbons removed.

- b) Dry Hole Abandoned Location

At such time as the well is plugged and abandoned, the operator shall submit a subsequent report of abandonment and the State of Utah will attach the appropriate surface rehabilitation conditions of approval.

11. **SURFACE OWNERSHIP** – Bureau of Land Management.

12. **OTHER ADDITIONAL INFORMATION**

The Archaeological Resource Survey and Paleontological Resource Survey for this area are attached. State of Utah Antiquities Project Permit #U-11-MQ-0265s 5/2/11, prepared by Montgomery Archaeological Consultants. Paleontological Resource Survey prepared by, Wade E. Miller, 5/31/11. See attached report cover pages, Exhibit "D".

Water Disposal

After first production, if the production water meets quality guidelines, it will be transported to the Ashley, Monument Butte, Jonah, South Wells Draw and Beluga water injection facilities by company or contract trucks. Subsequently, the produced water is injected into approved Class II wells to enhance Newfield's secondary recovery project. Water not meeting quality criteria, will be disposed at Newfield's Pariette #4 disposal well (Sec. 7, T9S R19E), Federally approved surface disposal facilities or at a State of Utah approved surface disposal facilities.

Additional Surface Stipulations

All lease and/or unit operations will be conducted in such a manner that full compliance is made with all applicable laws and regulations, Onshore Oil and Gas Orders, the approved plan of operations and any applicable Notice to Lessees. A copy of these conditions will be furnished to the field representative to ensure compliance.

Details of the On-Site Inspection

The proposed GMBU P-33-8-17 was on-sited on 9/8/11. The following were present; Tim Eaton (Newfield Production), Christine Cimiluca (Bureau of Land Management), and Aaron Roe (Bureau of Land Management).

Hazardous Material Declaration

Newfield Production Company guarantees that during the drilling and completion of the GMBU P-33-8-17, Newfield will not use, produce, store, transport or dispose 10,000# annually of any of the hazardous chemicals contained in the Environmental Protection Agency's consolidated list of chemicals subject to reporting under Title III Superfund Amendments and Reauthorization Act (SARA) of 1986. Newfield also guarantees that during the drilling and completion of the GMBU P-33-8-17, Newfield will use, produce, store, transport or dispose less than the threshold planning quantity (T.P.Q.) of any extremely hazardous substances as defined in 40 CFR 355.

A complete copy of the approved APD, if applicable, shall be on location during the construction of the location and drilling activities.

Newfield Production Company or a contractor employed by Newfield Production shall contact the State office at (801) 722-3417, 48 hours prior to construction activities.

13. LESSEE'S OR OPERATOR'S REPRESENTATIVE AND CERTIFICATION:

Representative

Name: Tim Eaton

Address: Newfield Production Company
Route 3, Box 3630
Myton, UT 84052

Telephone: (435) 646-3721

Certification

Please be advised that NEWFIELD PRODUCTION COMPANY is considered to be the operator of well #P-33-8-17, Section 32, Township 8S, Range 17E: Lease UTU-77234 Duchesne County, Utah: and is responsible under the terms and conditions of the lease for the operations conducted upon the leased lands. Bond coverage is provided by, Federal Bond #WYB000493.


I hereby certify that the proposed drill site and access route have been inspected, and I am familiar with the conditions which currently exist; that the statements made in this plan are true and correct to the best of my knowledge; and that the work associated with the operations proposed here will be performed by Newfield Production Company and its contractors and subcontractors in conformity with this plan and the terms and

conditions under which it is approved. This statement is subject to the provisions of the 18 U.S.C. 1001 for the filing of a false statement.

10/25/11
Date

Mandie Crozier
Regulatory Analyst
Newfield Production Company

Typical 2M BOP stack configuration

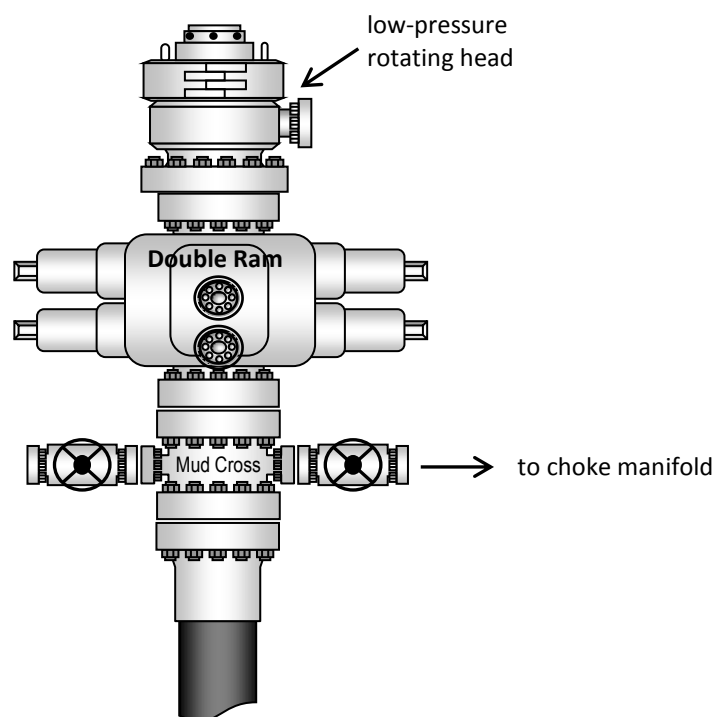

NEWFIELD EXPLORATION COMPANY**WELL PAD INTERFERENCE PLAT****P-33-8-17 (Proposed Well)****9-32-8-17 (Existing Well)***Pad Location: NESE Section 32, T8S, R17E, S.L.B.&M.***CENTER OF PATTERN FOOTAGES**

P-33-8-17 (PROPOSED)
1315' FSL & 50' FEL

TOP HOLE FOOTAGES

P-33-8-17 (PROPOSED)
2073' FSL & 991' FEL

Existing
Anchor
(Typ.)

Edge of
Existing Pad

Future Pit

9-32-8-17 (EXISTING)

Injection
Shed

P-33-8-17 (PROPOSED)

BOTTOM HOLE FOOTAGES

P-33-8-17 (PROPOSED)
1057' FSL & 270' FWL

Existing Access

(To Bottom Hole)
S52°08'14"E - 1615.68'
S52°08'14"E - 1205.79'
(To C.O.P.)

Note:

Bearings are based
on GPS Observations.

RELATIVE COORDINATES*From Top Hole to Bottom Hole*

WELL	NORTH	EAST
P-33-8-17	-992'	1276'

RELATIVE COORDINATES*From Top Hole to C.O.P.*

WELL	NORTH	EAST
P-33-8-17	-740'	952'

LATITUDE & LONGITUDE*Surface position of Wells (NAD 83)*

WELL	LATITUDE	LONGITUDE
P-33-8-17	40° 04' 22.27"	110° 01' 28.23"
9-32-8-17	40° 04' 22.47"	110° 01' 28.19"

SURVEYED BY: D.G.	DATE SURVEYED: 01-17-11
DRAWN BY: M.W.	DATE DRAWN: 01-28-11
SCALE: 1" = 50'	REVISED:

Tri State
Land Surveying, Inc.
180 NORTH VERNAL AVE. VERNAL, UTAH 84078
(435) 781-2501

RECEIVED: October 26, 2011


NEWFIELD EXPLORATION COMPANY

LOCATION LAYOUT

P-33-8-17 (Proposed Well)

9-32-8-17 (Existing Well)

Pad Location: NESE Section 32, T8S, R17E, S.L.B.&M.

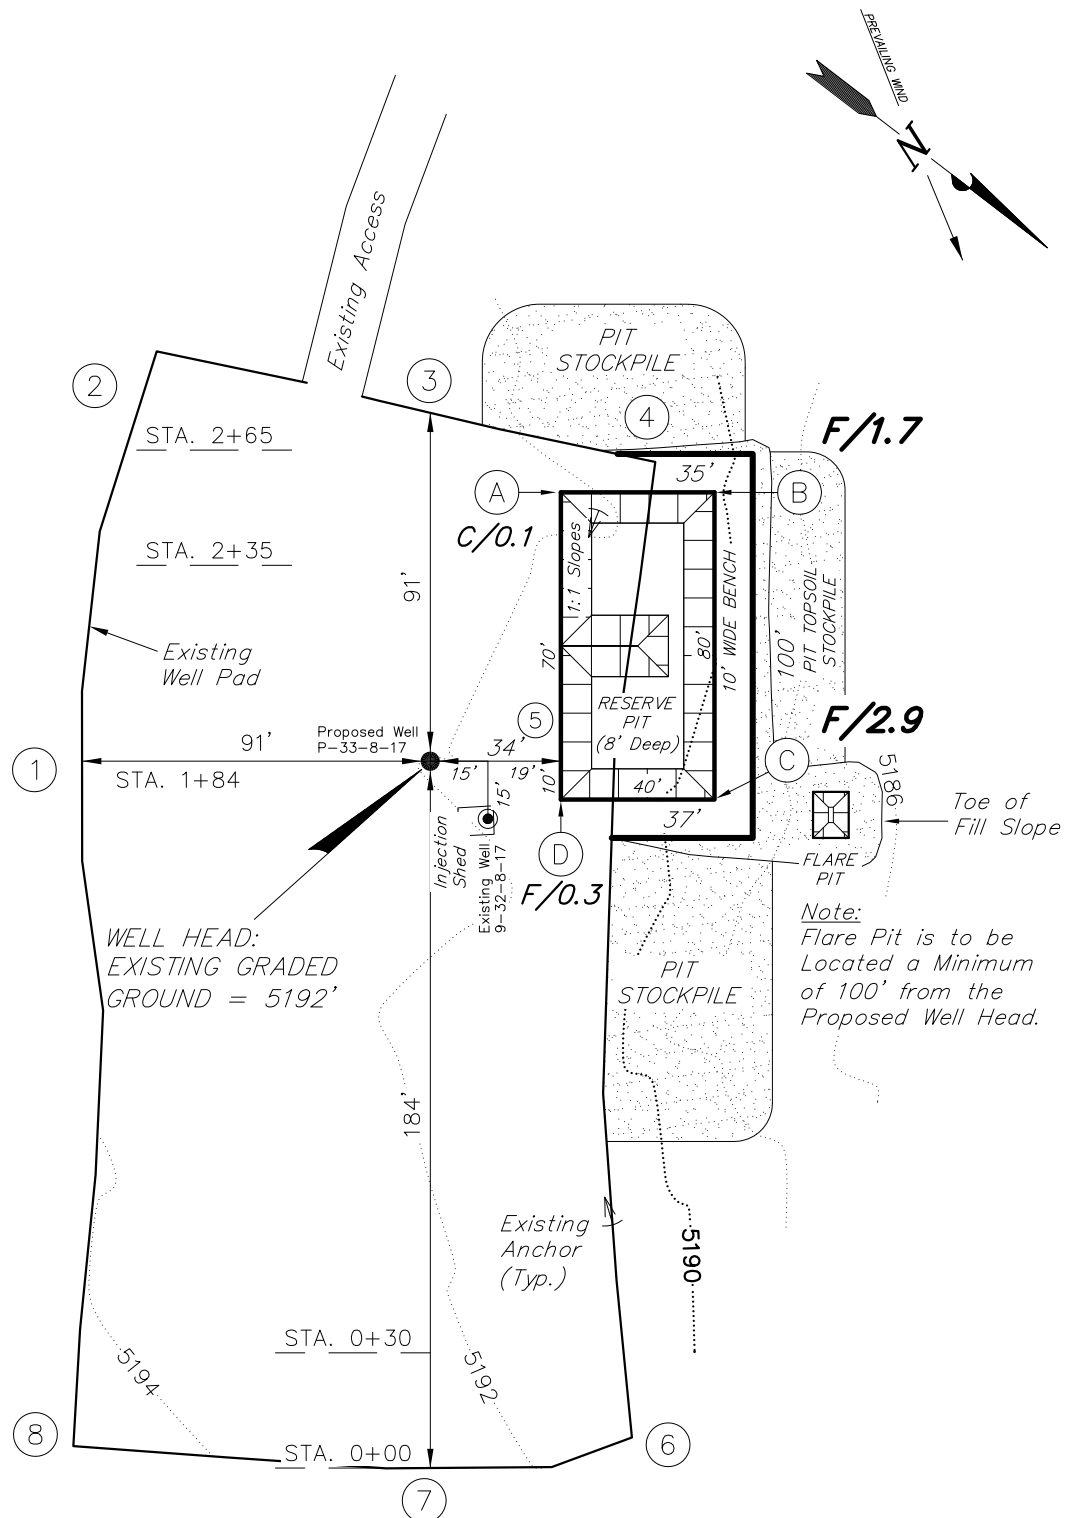

SURVEYED BY: D.G.

DATE SURVEYED:

01-17-11

DRAWN BY: M.W.

DATE DRAWN:

01-28-11

SCALE: 1" = 50'

REVISED:

Tri State
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180 NORTH VERNAL AVE. VERNAL, UTAH 84078

RECEIVED: October 26, 2011





NEWFIELD EXPLORATION COMPANY

CROSS SECTIONS

P-33-8-17 (Proposed Well)

9-32-8-17 (Existing Well)

Pad Location: NESE Section 32, T8S, R17E, S.L.B.&M.

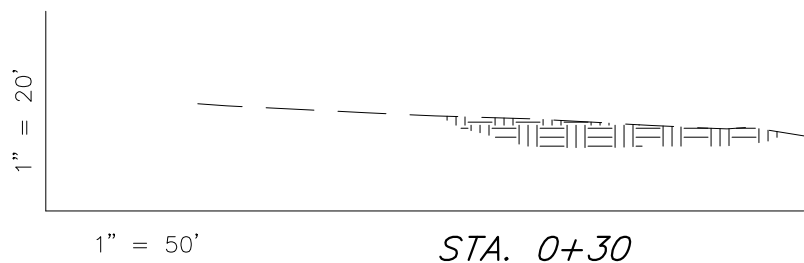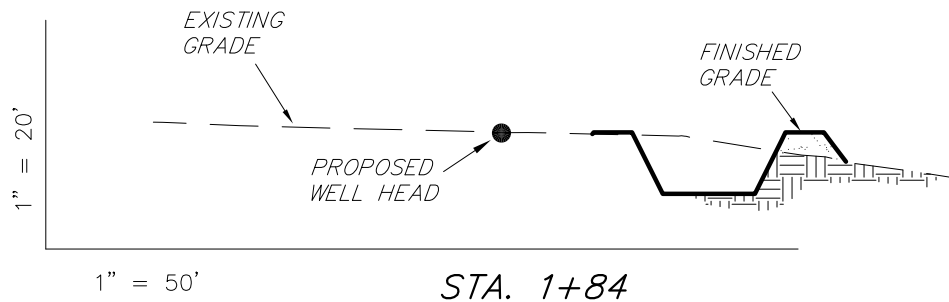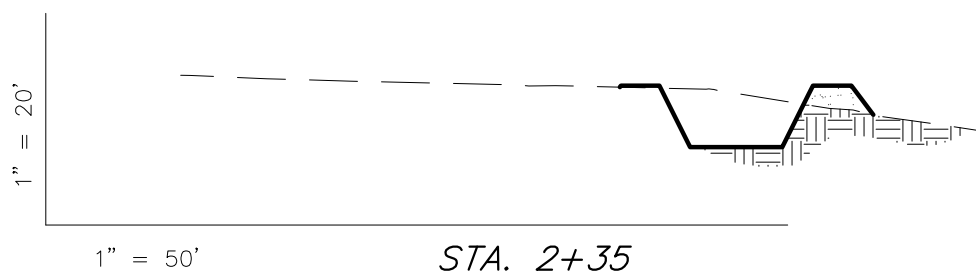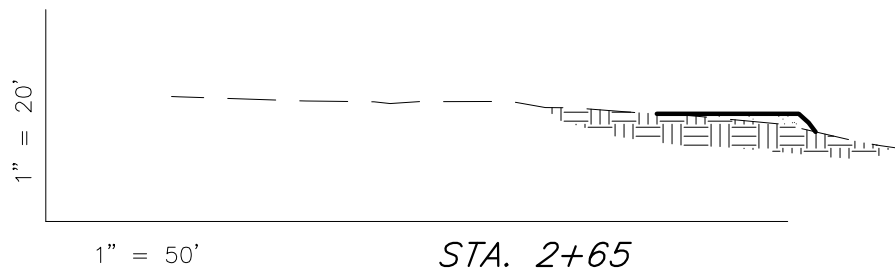

NOTE:
UNLESS OTHERWISE NOTED
CUT SLOPES ARE AT 1:1
FILL SLOPES ARE AT 1.5:1

ESTIMATED EARTHWORK QUANTITIES (No Shrink or swell adjustments have been used) (Expressed in Cubic Yards)

ITEM	CUT	FILL	6" TOPSOIL	EXCESS
PAD	0	260	Topsoil is not included in Pad Cut	-260
PIT	640	0		640
TOTALS	640	260	140	380

SURVEYED BY: D.G.	DATE SURVEYED: 01-17-11
DRAWN BY: M.W.	DATE DRAWN: 01-28-11
SCALE: 1" = 50'	REVISED:

Tri State
Land Surveying, Inc.
180 NORTH VERNAL AVE. VERNAL, UTAH 84078
(435) 781-2501

RECEIVED: October 26, 2011


NEWFIELD EXPLORATION COMPANY

TYPICAL RIG LAYOUT

P-33-8-17 (Proposed Well)

9-32-8-17 (Existing Well)



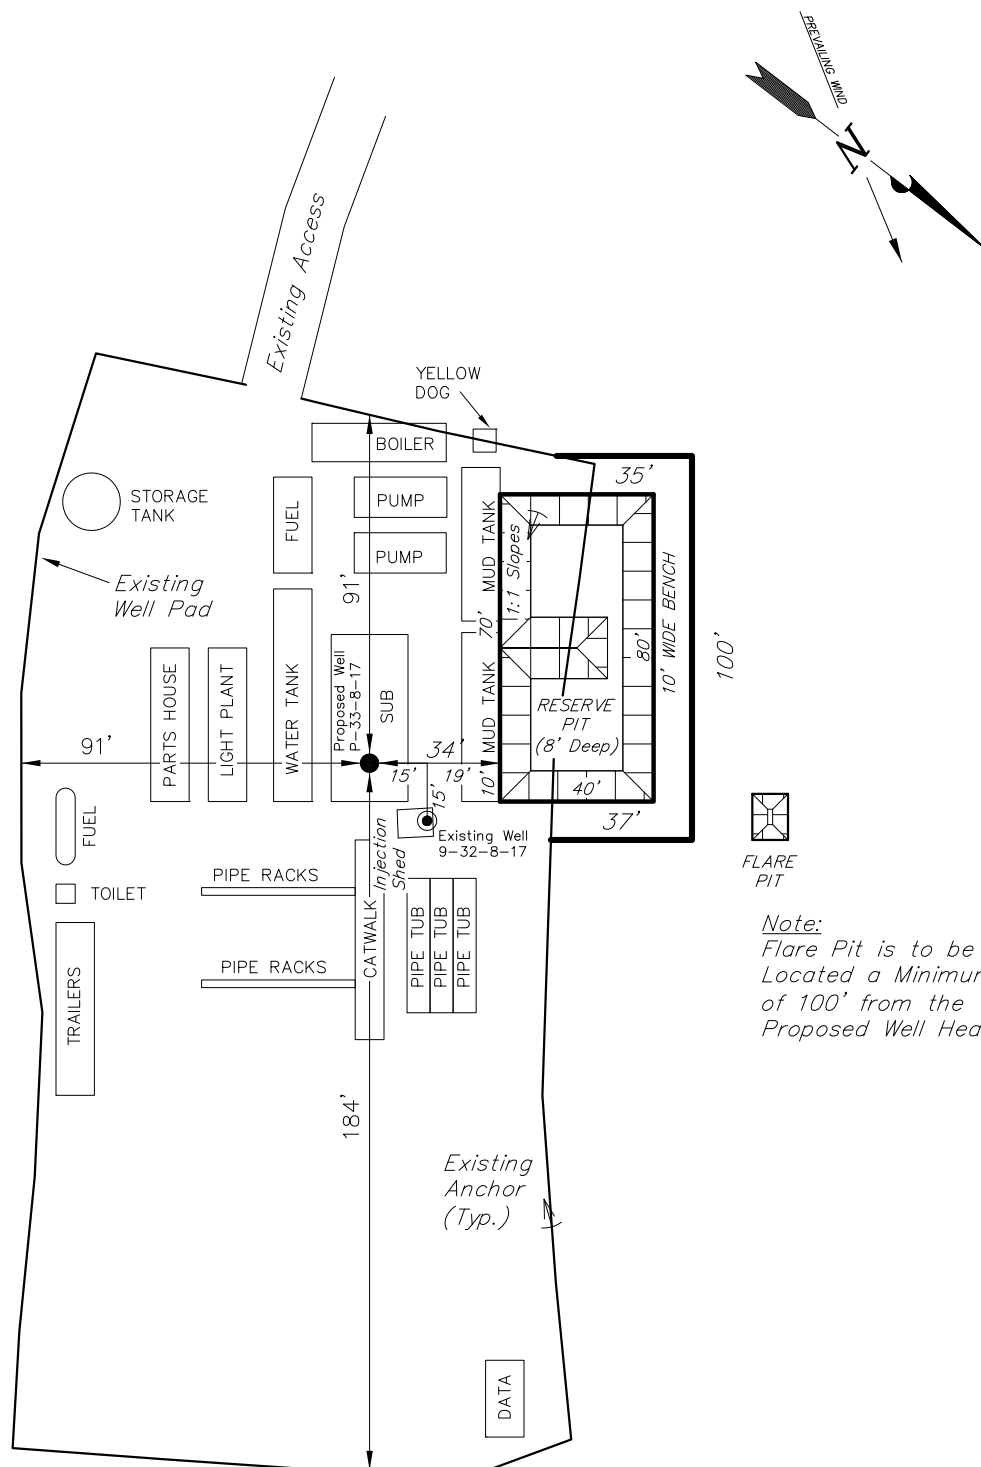

































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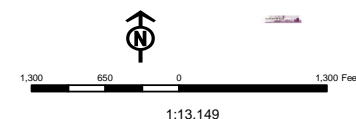


SURVEYED BY: D.G.	DATE SURVEYED: 01-17-11
DRAWN BY: M.W.	DATE DRAWN: 01-28-11
SCALE: 1" = 50'	REVISED:

Tri State
Land Surveying, Inc.
(435) 781-2501
180 NORTH VERNAL AVE. VERNAL, UTAH 84078

RECEIVED: October 26, 2011

Units	Wells Query
 ACTIVE	 APD - Approved Permit
 EXPLORATORY	 DRL - Spudded (Drilling Commenced)
 GAS STORAGE	 GW - Gas Injection
 NF PP OIL	 GS - Gas Storage
 NF SECONDARY	
 PI OIL	 LA - Location Abandoned
 PP GAS	 LOC - New Location
 PP GEOTHERMAL	 OPS - Operation Suspended
 PP OIL	 PA - Plugged Abandoned
 SECONDARY	 PGW - Producing Gas Well
 TERMINATED	 POW - Producing Oil Well
	 RET - Returned APD
Fields STATUS	 SGW - Shut-in Gas Well
 Unknown	 SOW - Shut-in Oil Well
 ABANDONED	 TA - Test, Abandoned
 ACTIVE	 TW - Test Well
 COMBINED	 WDW - Water Disposal
 INACTIVE	 WW - Water Injection Well
 STORAGE	 WSW - Water Supply Well
 TERMINATED	



United States Department of the Interior

BUREAU OF LAND MANAGEMENT

Utah State Office
P.O. Box 45155
Salt Lake City, Utah 84145-0155

IN REPLY REFER TO:
3160
(UT-922)

October 28, 2011

Memorandum

To: Assistant District Manager Minerals, Vernal District
From: Michael Coulthard, Petroleum Engineer
Subject: 2011 Plan of Development Greater Monument
Butte Unit, Duchesne and Uintah Counties,
Utah.

Pursuant to email between Diana Whitney, Division of Oil, Gas and Mining, and Mickey Coulthard, Utah State Office, Bureau of Land Management, the following wells are planned for calendar year 2011 within the Greater Monument Butte Unit, Duchesne and Uintah Counties, Utah.

API#	WELL NAME	LOCATION
(Proposed PZ GREEN RIVER)		
43-013-51018	GMBU X-28-8-17	Sec 33 T08S R17E 0695 FNL 0848 FWL BHL Sec 28 T08S R17E 0182 FSL 1412 FWL
43-013-51019	GMBU U-29-8-17	Sec 33 T08S R17E 0708 FNL 0831 FWL BHL Sec 29 T08S R17E 0080 FSL 0117 FEL
43-013-51020	GMBU Q-29-8-17	Sec 29 T08S R17E 0637 FSL 1973 FWL BHL Sec 29 T08S R17E 1520 FSL 1217 FWL
43-013-51021	GMBU D-32-8-17	Sec 29 T08S R17E 0618 FSL 1965 FWL BHL Sec 32 T08S R17E 0071 FNL 1096 FWL
43-013-51022	GMBU R-33-8-17	Sec 33 T08S R17E 0631 FSL 1958 FEL BHL Sec 33 T08S R17E 1726 FSL 2481 FWL
43-013-51023	GMBU C-4-9-17	Sec 33 T08S R17E 0610 FSL 1957 FEL BHL Sec 04 T09S R17E 0345 FNL 2447 FWL
43-013-51025	GMBU B-31-8-17	Sec 30 T08S R17E 0650 FSL 1993 FEL BHL Sec 31 T08S R17E 0295 FNL 1077 FEL
43-013-51026	GMBU P-33-8-17	Sec 32 T08S R17E 2073 FSL 0911 FEL BHL Sec 33 T08S R17E 1057 FSL 0270 FWL

RECEIVED: October 28, 2011

API #	WELL NAME	LOCATION
(Proposed PZ GREEN RIVER)		
43-013-51027	GMBU Q-33-8-17	Sec 33 T08S R17E 0781 FSL 2330 FWL BHL Sec 33 T08S R17E 1251 FSL 0795 FWL
43-013-51028	GMBU P-34-8-17	Sec 33 T08S R17E 0700 FSL 0980 FEL BHL Sec 34 T08S R17E 1435 FSL 0275 FWL
43-013-51029	GMBU B-4-9-17	Sec 33 T08S R17E 0711 FSL 0999 FEL BHL Sec 04 T09S R17E 0265 FNL 1426 FEL

This office has no objection to permitting the wells at this time.

Michael L. Coulthard

Digitally signed by Michael L. Coulthard
DN: cn=Michael L. Coulthard, o=Bureau of Land Management,
ou=Branch of Minerals, email=Michael_Coulthard@blm.gov,
c=US
Date: 2011.10.28 10:49:37 -06'00'

bcc: File - Greater Monument Butte Unit
Division of Oil Gas and Mining
Central Files
Agr. Sec. Chron
Fluid Chron

MCoulthard:mc:10-28-11

RECEIVED: October 28, 2011



VIA ELECTRONIC DELIVERY

November 3, 2011

State of Utah, Division of Oil, Gas and Mining
ATTN: Diana Mason
P.O. Box 145801
Salt Lake City, UT 84114-5801

RE: Directional Drilling
GMBU P-33-8-17
Greater Monument Butte (Green River) Unit

Surface Hole: T8S-R17E Section 32: NESE (ML-22069)
2073' FSL 991' FEL

At Target: T8S-R17E Section 33: SWSW (UTU-77234)
1057' FSL 270' FWL

Duchesne County, Utah

Dear Ms. Mason:

Pursuant to the filing by Newfield Production Company (NPC) of an Application for Permit to Drill the above referenced well dated 10/26/2011, a copy of which is attached, and in accordance with Oil and Gas Conservation Rule R649-3-11, NPC hereby submits this letter as notice of our intention to directionally drill this well.

The surface hole and target locations of this well are both within the boundaries of the Greater Monument Butte Unit (UTU-87538X), of which Newfield certifies that it is the operator. Further, Newfield certifies that all lands within 460 feet of the entire directional well bore are within the Greater Monument Butte Unit.

NPC is permitting this well as a directional well in order to mitigate surface disturbance by utilizing pre-existing roads and pipelines.

NPC hereby requests our application for permit to drill be granted pursuant to R649-3-11. If you have any questions or require further information, please contact the undersigned at 303-383-4153 or by email at pburns@newfield.com. Your consideration in this matter is greatly appreciated.

Sincerely,
Newfield Production Company

A handwritten signature in blue ink, appearing to read "P. Burns".

Peter Burns
Land Associate

Form 3160-3
(August 2007)UNITED STATES
DEPARTMENT OF THE INTERIOR
BUREAU OF LAND MANAGEMENT**APPLICATION FOR PERMIT TO DRILL OR REENTER****Bold*** fields are required.

Section 1 - Completed by Operator	
1. BLM Office* Vernal, UT	2. Confidentiality <input type="checkbox"/> Confidential
3. Work Type* <input checked="" type="radio"/> DRILL <input type="radio"/> REENTER	4. Well Type* OIL
Operating Company Information	
5. Company Name* NEWFIELD PRODUCTION COMPANY	
6. Address* ROUTE #3 BOX 3630 MYTON UT 84052	7. Phone Number* 435-646-3721
Administrative Contact Information	
8. Contact Name* MANDIE _ CROZIER	9. Title* REGULATORY ANALYST
10. Address* ROUTE #3 BOX 3630 MYTON UT 84052	11. Phone Number* 435-646-4825 _
	12. Mobile Number 435-401-8335
13. E-mail* mcrozier@newfield.com	14. Fax Number 435-646-3031
Technical Contact Information	
<input checked="" type="checkbox"/> Check here if Technical Contact is the same as Administrative Contact.	
15. Contact Name* _____	16. Title* _____
17. Address* _____ _____ _____	18. Phone Number* _____ _____
	19. Mobile Number _____
20. E-mail* _____	21. Fax Number _____
Lease and Agreement	
22. Lease Serial Number*	

UTU77234			
24. If Unit or CA/Agreement, Name and/or Number GREATER MONUMENT BUTTE		25. Field and Pool, or Exploratory Area* MONUMENT BUTTE	
26. Number of Acres in Lease* 480		27. Spacing Unit dedicated to this well 20	
Well			
28. Well Name* GMBU		29. Well Number* P-33-8-17	30. API Number _____
31. Proposed M.D. 6469	32. Proposed T.V.D. 6225	33. Elevation 5192 Ground Level	
34. BLM/BIA Bond Number WYB000493		35. Work Start Date 03/31/2012	36. Work Duration 7 DAYS
37. Number of Completions 1		38. Cable Tool <input type="radio"/> Cable <input checked="" type="radio"/> Rotary	
Surface Location			
39. Specify location using one of the following methods: a) State, County, Section, Township, Range, Meridian, N/S Footage, E/W Footage, with Qtr/Qtr, Lot, or Tract b) State, County, Latitude, Longitude, Metes & Bounds description			
County or Parish, State* DUCHESNE UT			
Section 32	Township 8S	Range 17E	Meridian SALT LAKE BASIN
Qtr/Qtr NESE	Lot # _____	Tract # _____	N/S Footage 2073 FSL
			E/W Footage 991 FEL
Latitude _____	Longitude _____	Metes and Bounds	
40. Distance in miles and direction from nearest town or post office 11.3			
41. Distance from proposed location to nearest property or lease line, ft. (Also to nearest drig. unit line, if any) 270'			
42. Distance from proposed location to nearest well, drilling, completed, applied for, on this lease, ft. 1480'			
Bottom Hole Location			
43. Specify location or <input type="checkbox"/> Check here if the bottom hole location is the same as the surface location.			
County or Parish, State* DUCHESNE UT			
Section 33	Township 8S	Range 17E	Meridian SALT LAKE BASIN
Qtr/Qtr	Lot #	Tract #	N/S Footage
			E/W Footage

SWSW			1057 FSL	270 FWL
Latitude	Longitude	Metes and Bounds		

44. Additional Information

Please provide any additional pertinent information.

SURFACE LEASE: ML-22069

BOTTOM HOLE LEASE: UTU-77234 (First Federal Lease Penetrated for Production)

I hereby certify that the foregoing is true and correct.

45. Name*

MANDIE _ CROZIER

46. Title

REGULATORY ANALYST


47. Date* (MM/DD/YYYY)10/26/2011 **48. Signature****You have the ability to sign this form only if a SmartCard or digital certificate has been issued to you.*

Title 18 U.S.C. Section 1001 and Title 43 U.S.C. Section 1212, make it a crime for any person knowingly and willfully to make to any department or agency of the United States any false, fictitious or fraudulent statements or representations as to any matter within its jurisdiction.

T8S, R17E, S.L.B.&M.

NEWFIELD EXPLORATION COMPANY

WELL LOCATION, P-33-8-17, LOCATED AS SHOWN IN THE NE 1/4 SE 1/4 OF SECTION 32, T8S, R17E, S.L.B.&M. DUCHESNE COUNTY, UTAH.

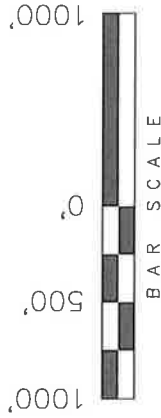

NOTES:

- 1. Well footages are measured at right angles to the Section Lines.
- 2. Bearings are based on Global Positioning Satellite observations.
- 3. The Center of Pattern footages are 1315' FSL & 50' FEL.

WELL LOCATION:
P-33-8-17

ELEV. EXIST. GRADED GROUND = 5192'

THIS IS TO CERTIFY THAT THE ABOVE PLOT WAS PREPARED FROM FIELD NOTES OF ACTUAL SURVEYS MADE BY ME OR UNDER MY SUPERVISION AND THAT THE SAME ARE TRUE AND CORRECT TO THE BEST OF MY KNOWLEDGE AND BELIEF.

REGISTERED LAND SURVEYOR

STACY W.

REGISTRATION NO. 189377

STATE OF UTAH

01-28-11


TRI STATE LAND SURVEYING & CONSULTING

180 NORTH VERNAL AVE. - VERNAL, UTAH 84078
(435) 781-2501

DATE SURVEYED: 01-17-11	SURVEYED BY: D.G.
DATE DRAWN: 01-28-11	DRAWN BY: M.W.
REVISED:	SCALE: 1" = 1000'


P-33-8-17
(Surface Location) NAD 83
LATITUDE = 40° 04' 22.27"
LONGITUDE = 110° 01' 28.23"

SECTION CORNERS LOCATED
BASIS OF ELEV.; Elevations are based on an N.G.S. OPUS Correction. LOCATION: LAT. 40°04'09.56" LONG. 110°00'43.28" (Tristate Aluminum Cap) Elev. 5281.57'

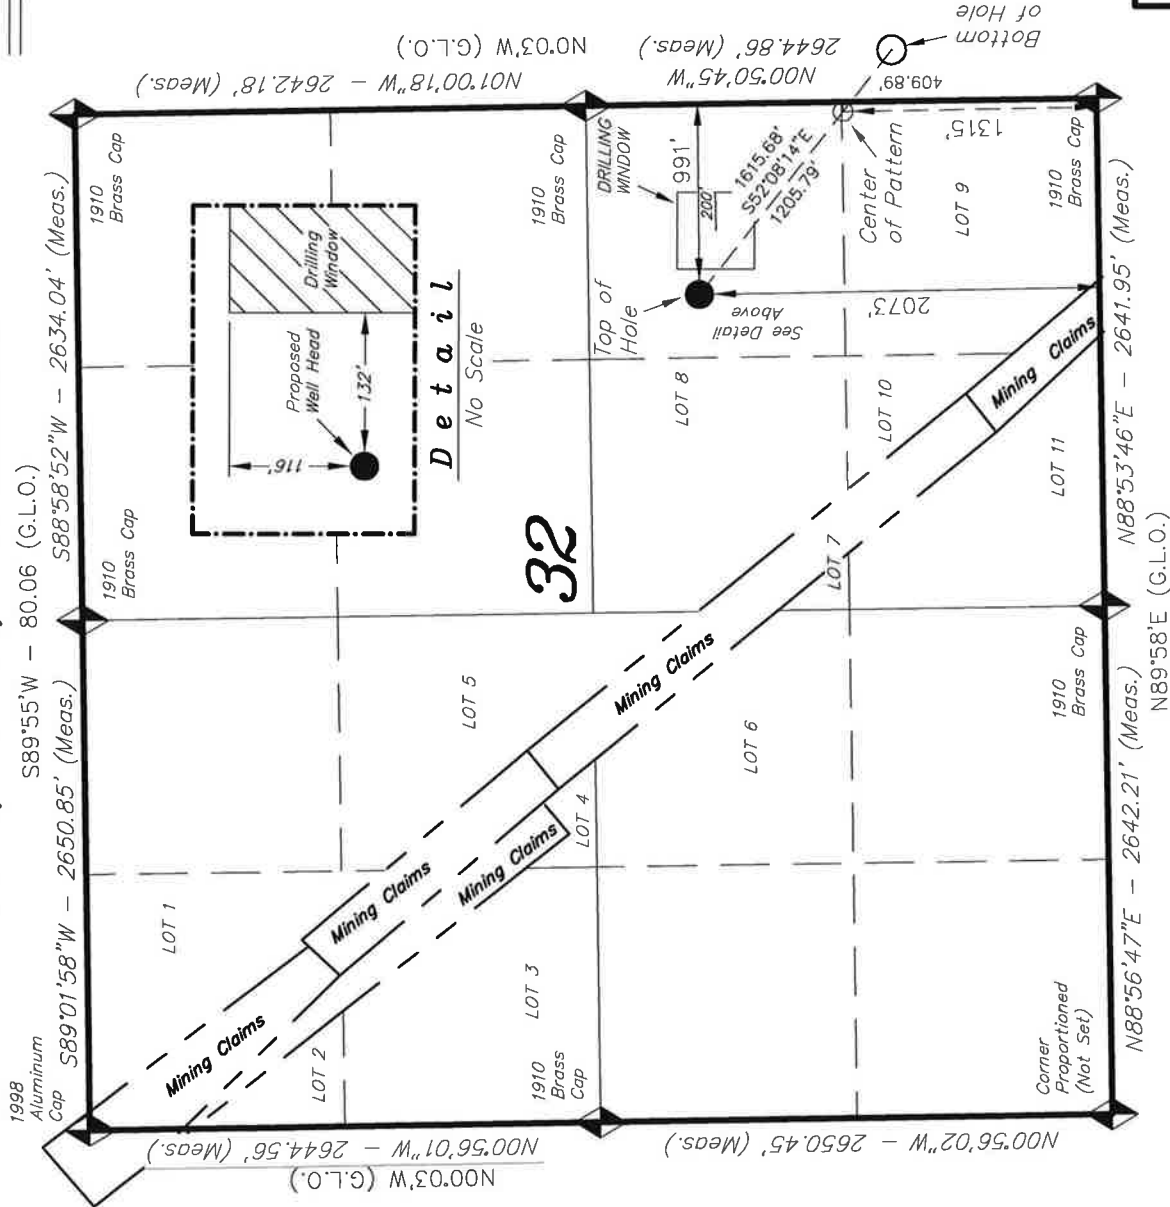


T8S, R17E, S.L.B.&M.

NEWFIELD EXPLORATION COMPANY

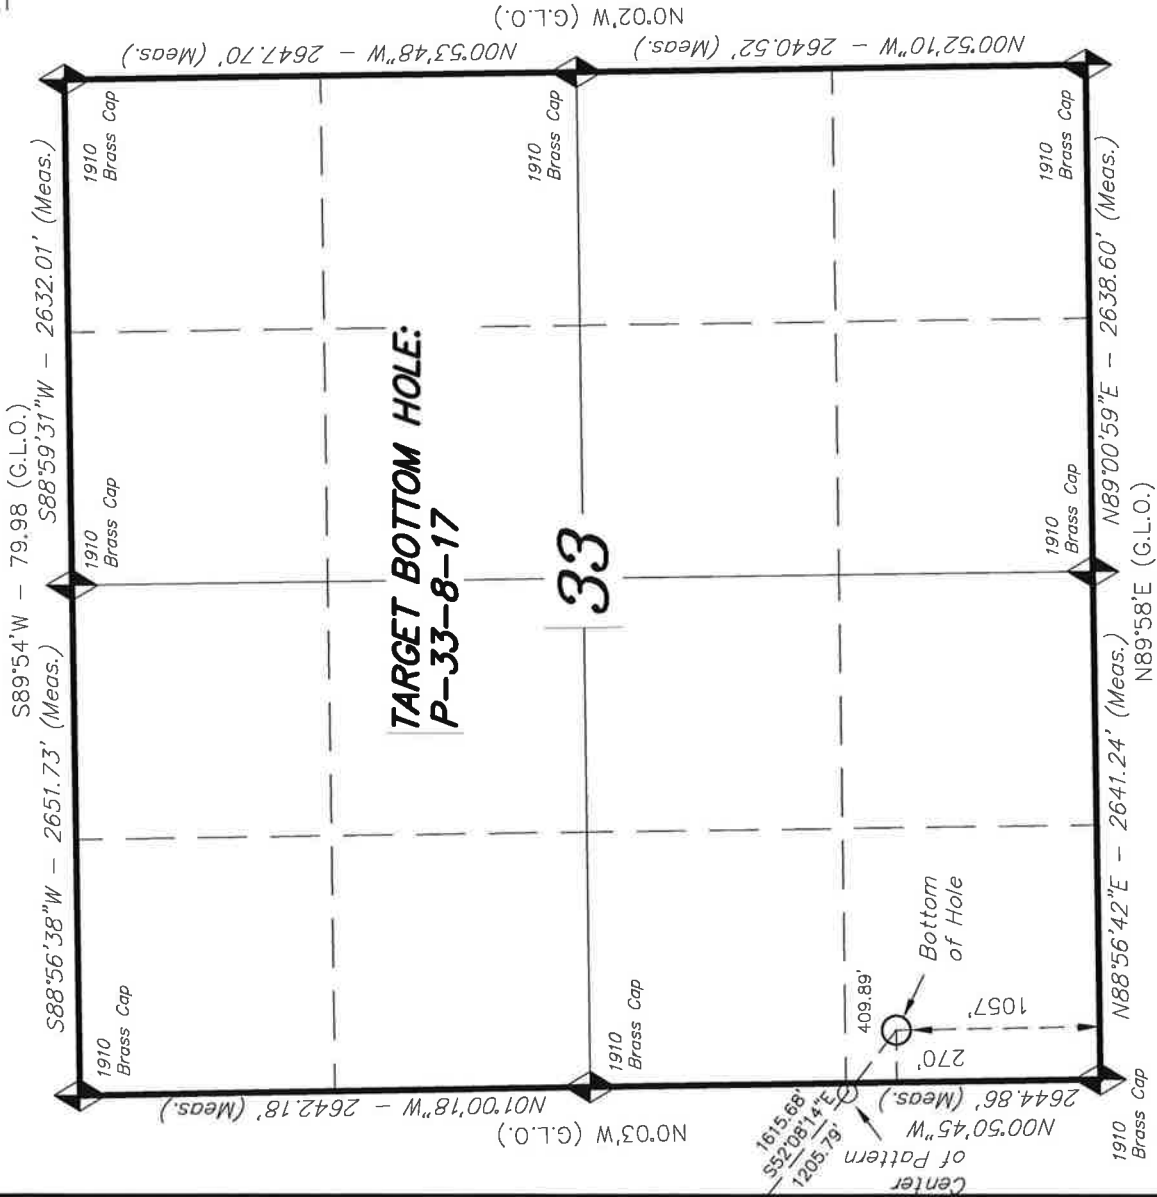

TARGET BOTTOM HOLE, P-33-8-17, LOCATED AS SHOWN IN THE SW 1/4 SW 1/4 OF SECTION 33, T8S, R17E, S.L.B.&M. DUCHESNE COUNTY, UTAH.

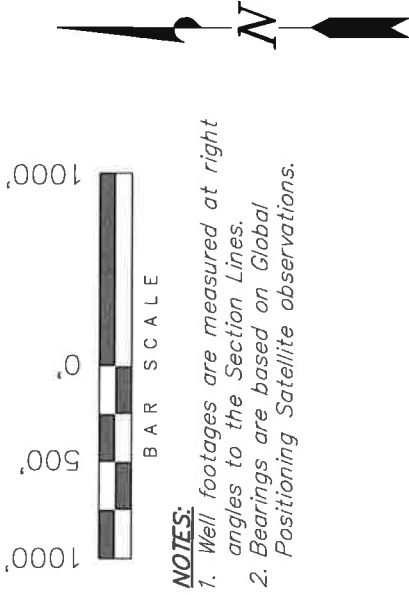

THIS IS TO CERTIFY THAT THE ABOVE PLAT WAS PREPARED FROM FIELD NOTES OF ACTUAL SURVEYS MADE BY ME OR UNDER MY SUPERVISION AND THAT THE SAME ARE TRUE AND CORRECT TO THE BEST OF MY KNOWLEDGE AND BELIEF.

REGISTERED LAND SURVEYOR
REGISTRATION NO. 189377
STATE OF UTAH

STACY W.


TRI STATE LAND SURVEYING & CONSULTING

180 NORTH VERNAL AVE. - VERNAL, UTAH 84078
(435) 781-2501

DATE SURVEYED: 01-17-11	SURVEYED BY: D.G.
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REVISED:	SCALE: 1" = 1000'

SECTION CORNERS LOCATED

BASIS OF ELEV; Elevations are based on an N.G.S. OPUS Correction. LOCATION: LAT. 40°04'09.56" LONG. 110°00'43.28" (Tristate Aluminum Cap) Elev. 5281.57'

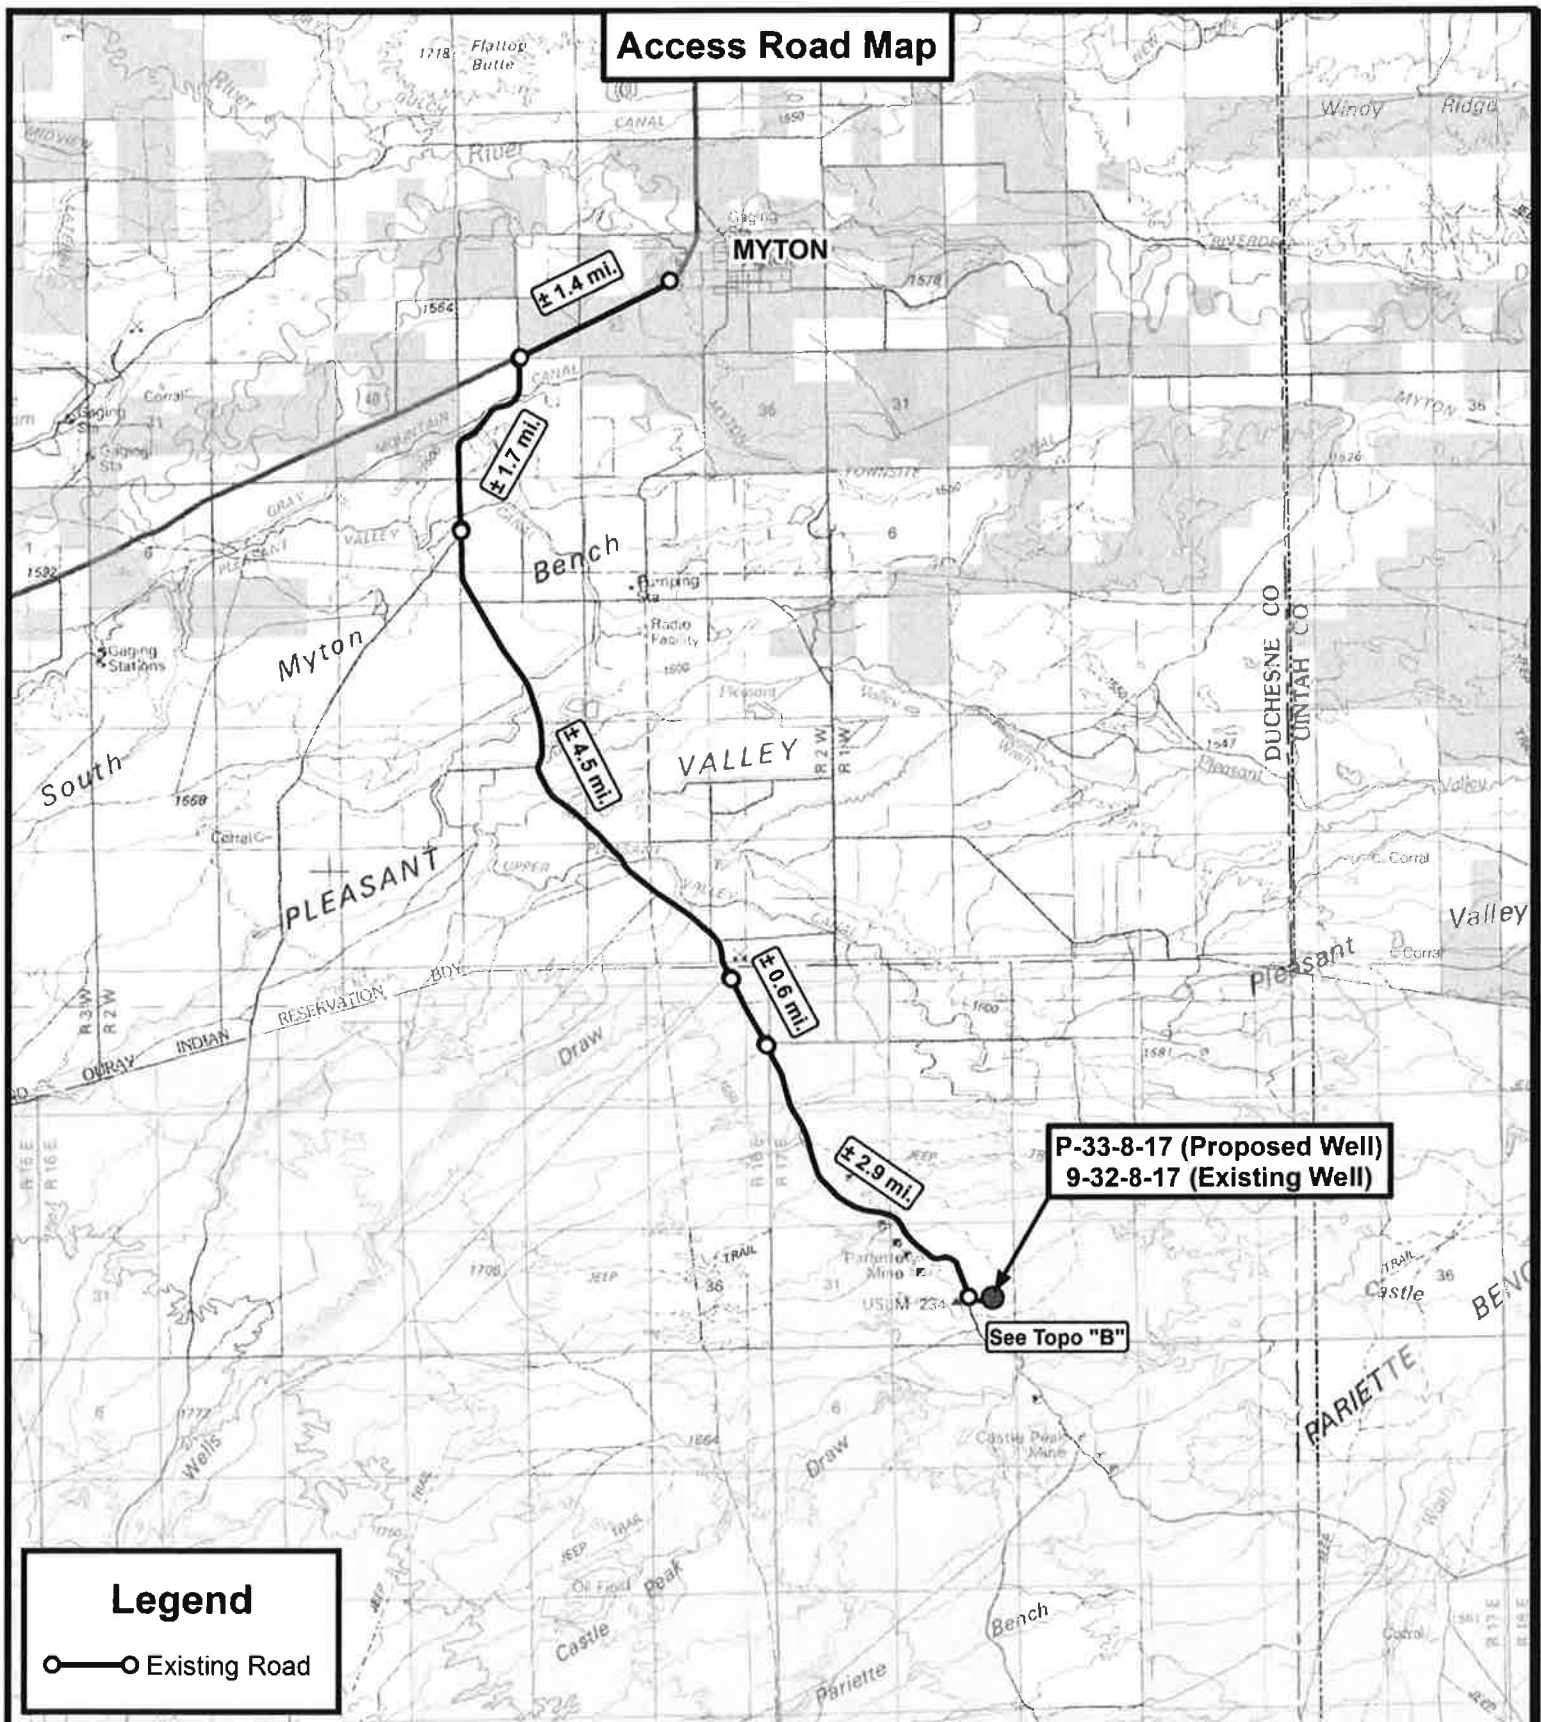

**Tri State
Land Surveying, Inc.**

180 NORTH VERNAL AVE. VERNAL, UTAH 84078

P: (435) 781-2501
F: (435) 781-2518




NEWFIELD EXPLORATION COMPANY

P-33-8-17 (Proposed Well)
 9-32-8-17 (Existing Well)
 SEC. 32, T8S, R17E, S.L.B.&M.
 Duchesne County, UT.

DRAWN BY:	C.H.M.
DATE:	02-23-2011
SCALE:	1:100,000

TOPOGRAPHIC MAP

SHEET
A

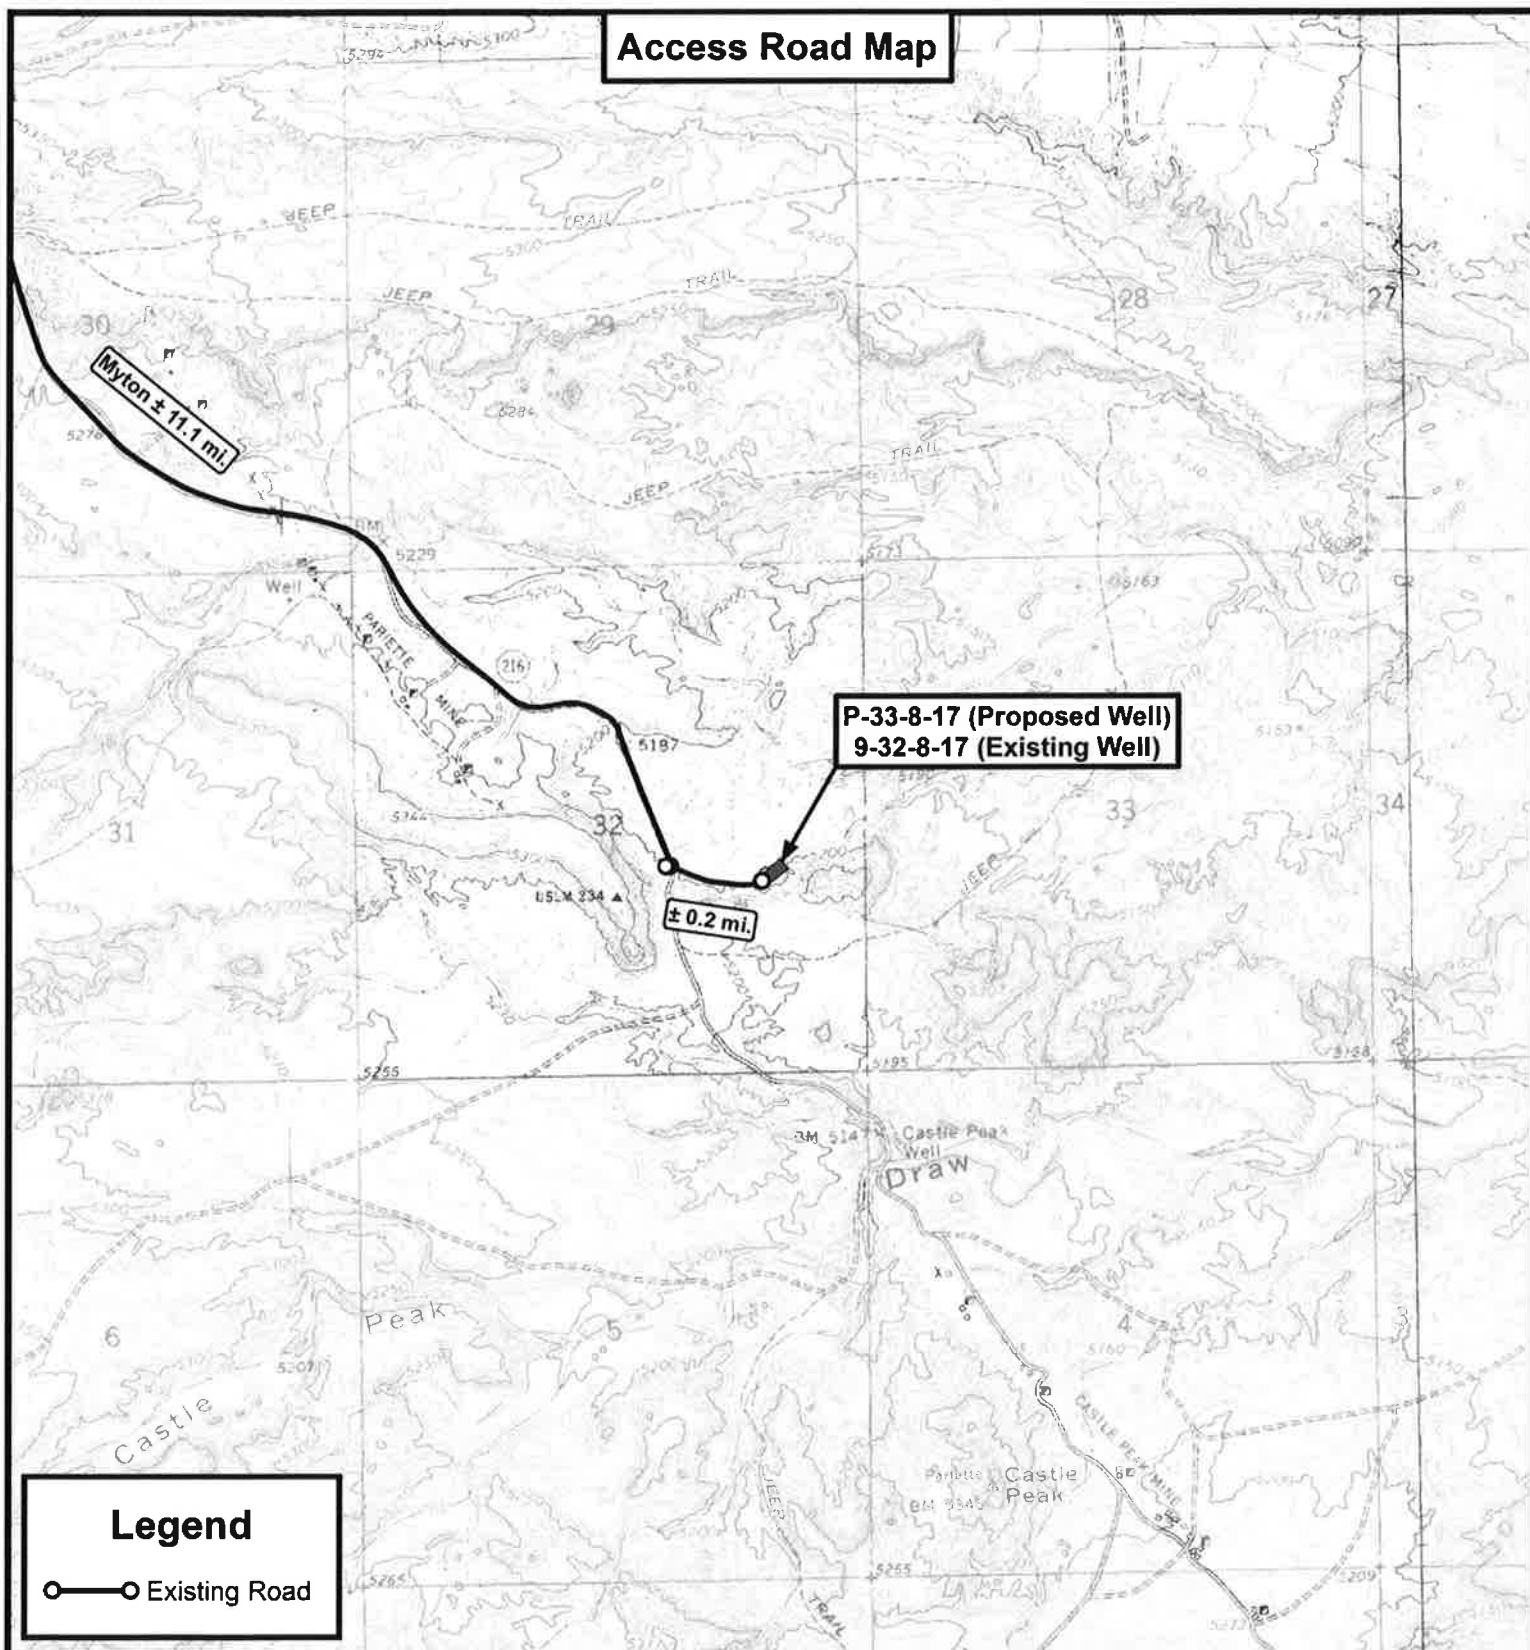

THE PARCEL INFORMATION SHOWN HAS NOT BEEN SURVEYED BY TRI-STATE LAND SURVEYING, INC. - TRI-STATE DOES NOT WARRANTY PROPERTY PARCEL DATA OR ANY ASSOCIATED INFORMATION. A PROPERTY SURVEY IS REQUIRED TO DETERMINE THE ACTUAL LOCATION OF PROPERTY LINES AND SHOW ACCURATE DISTANCES ACROSS PARCELS.



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180 NORTH VERNAL AVE. VERNAL, UTAH 84078

P: (435) 781-2501
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NEWFIELD EXPLORATION COMPANY


P-33-8-17 (Proposed Well)
9-32-8-17 (Existing Well)
SEC. 32, T8S, R17E, S.L.B.&M.
Duchesne County, UT.

DRAWN BY:	C.H.M.
DATE:	02-23-2011
SCALE:	1" = 2,000'

TOPOGRAPHIC MAP

SHEET
B

Proposed Pipeline Map

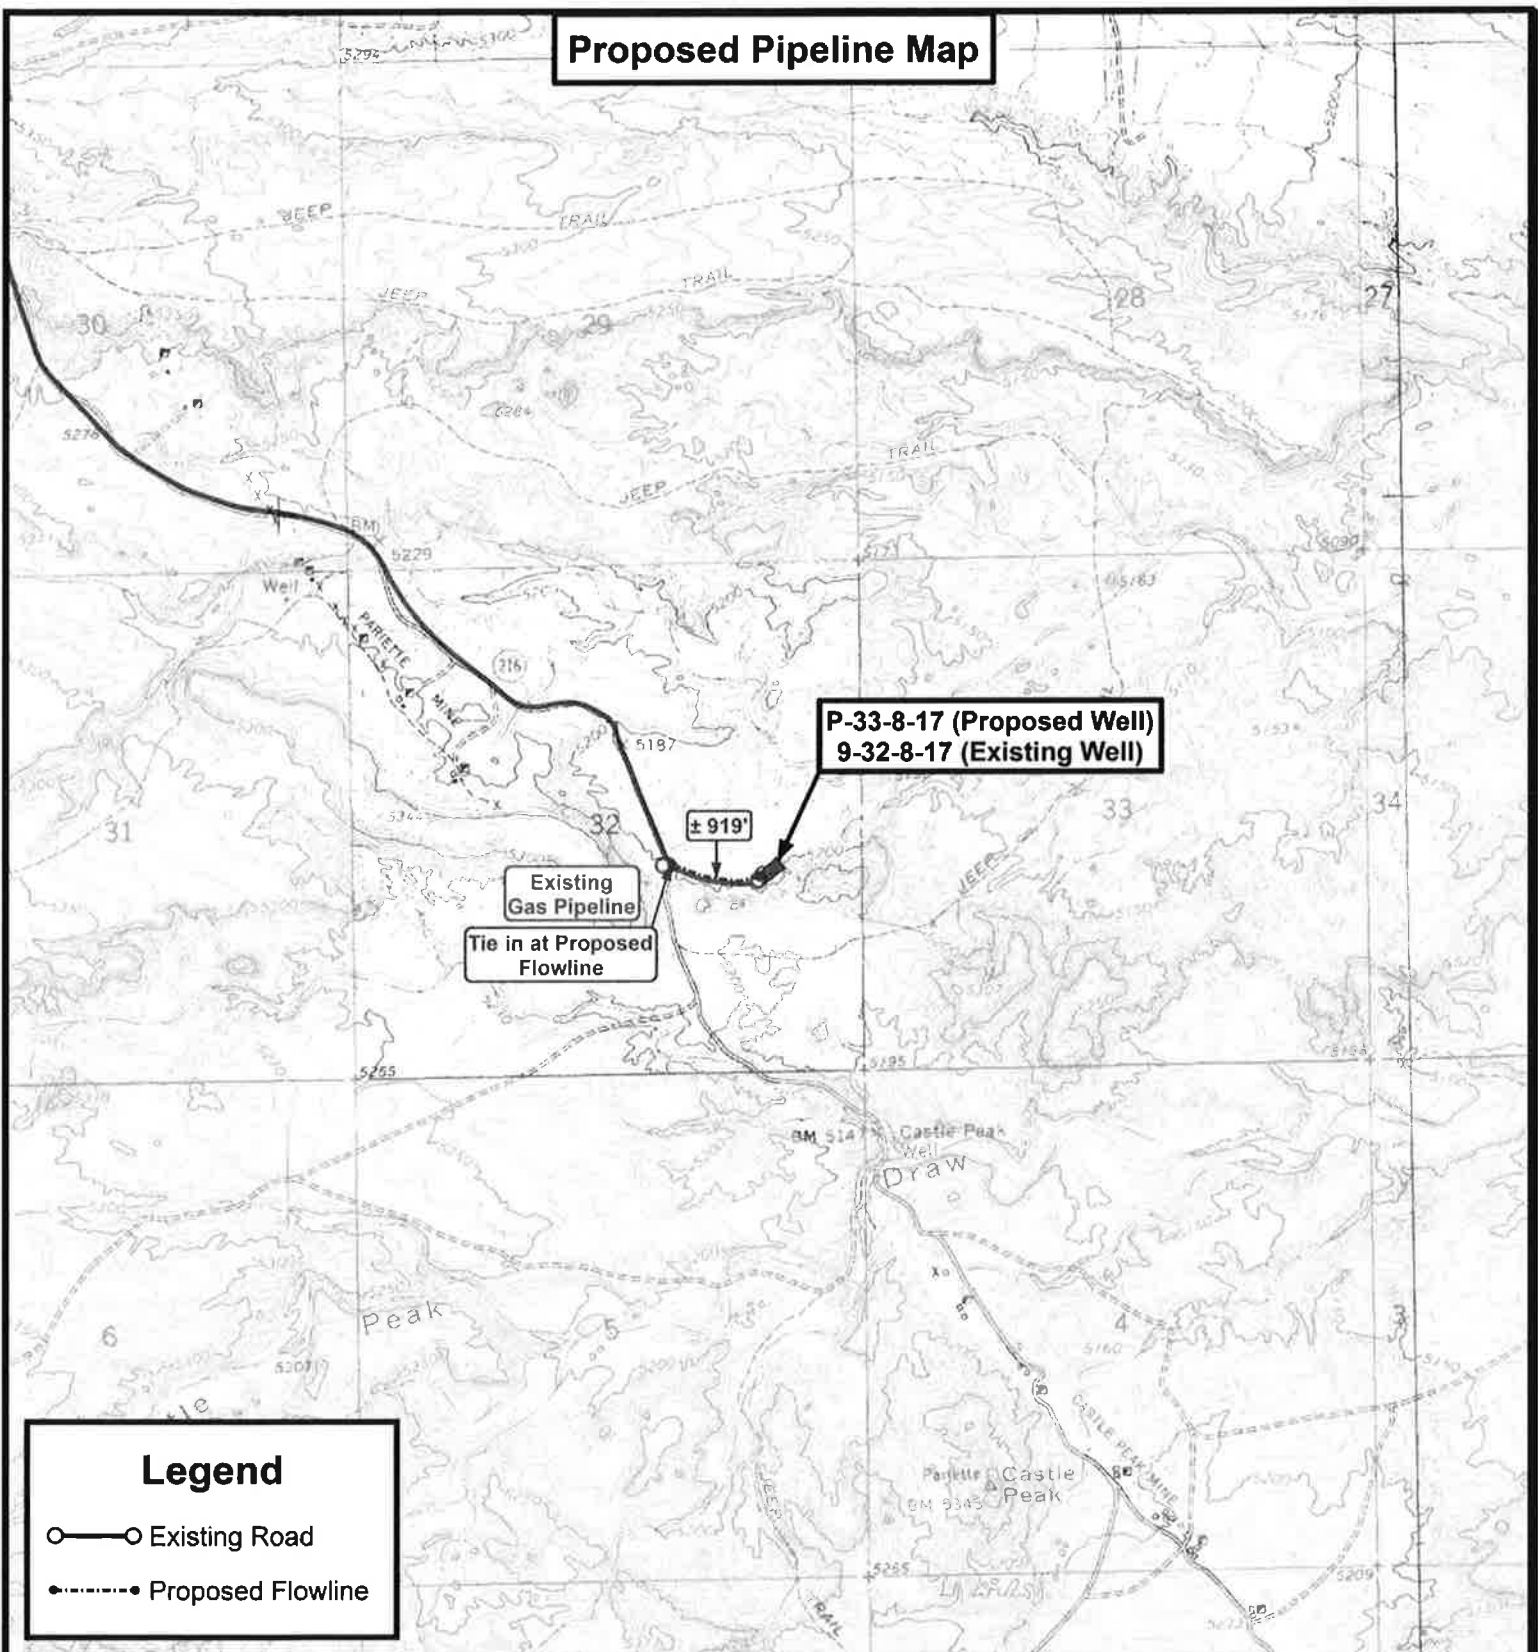

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NEWFIELD EXPLORATION COMPANY

P-33-8-17 (Proposed Well)
9-32-8-17 (Existing Well)
SEC. 32, T8S, R17E, S.L.B.&M.
Duchesne County, UT.


DRAWN BY: C.H.M.
DATE: 02-23-2011
SCALE: 1" = 2,000'

TOPOGRAPHIC MAP

SHEET
C

Exhibit "B" Map

P-33-8-17 (Proposed Well)
9-32-8-17 (Existing Well)

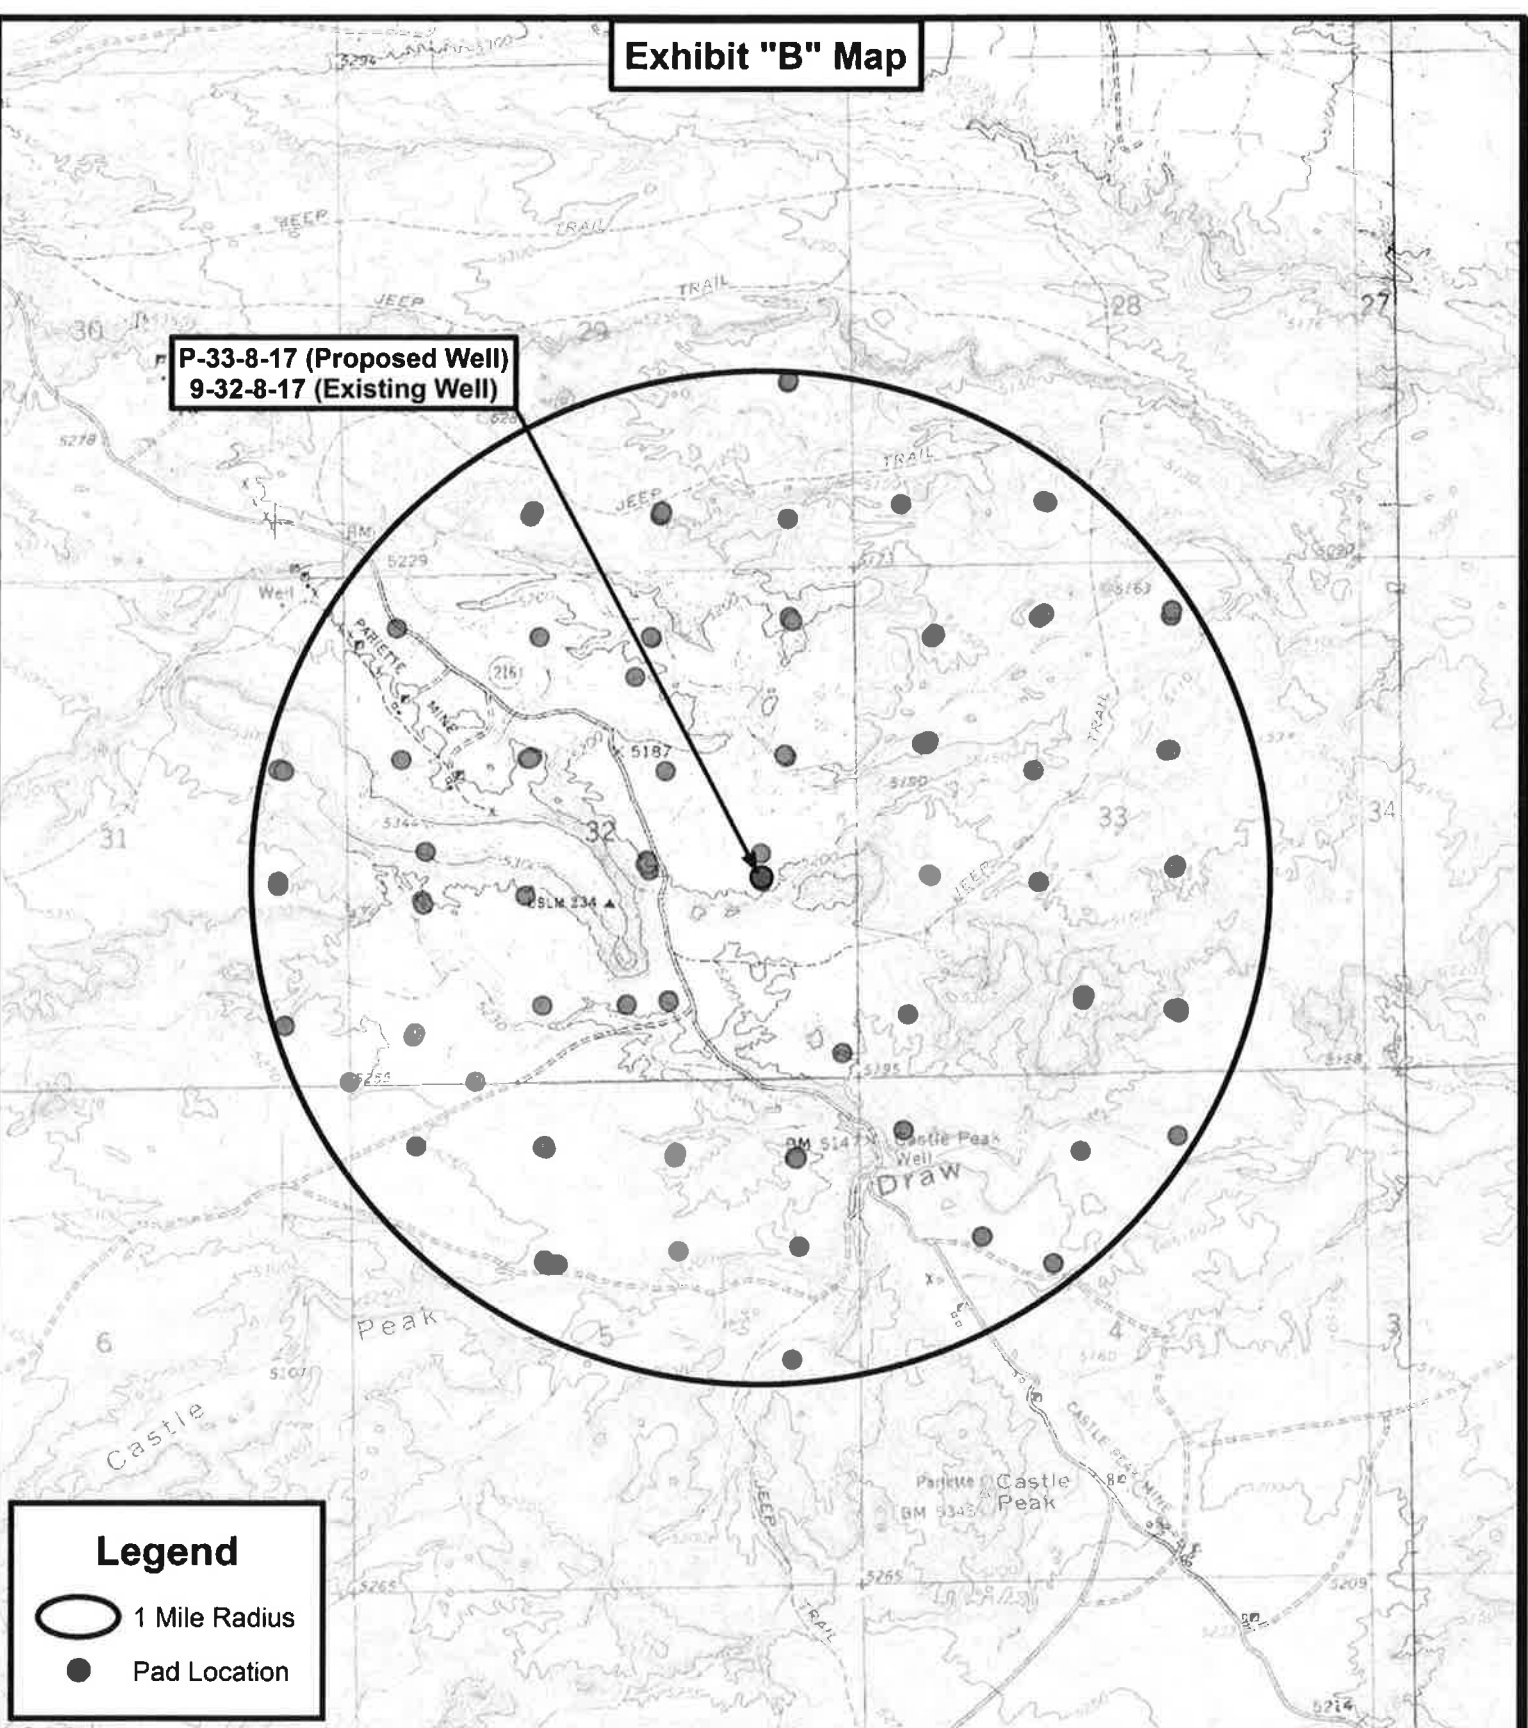

Legend

-  1 Mile Radius
-  Pad Location

Tri State
Land Surveying, Inc.
 180 NORTH VERNAL AVE. VERNAL, UTAH 84078

P: (435) 781-2501
 F: (435) 781-2518



NEWFIELD EXPLORATION COMPANY

P-33-8-17 (Proposed Well)
9-32-8-17 (Existing Well)
SEC. 32, T8S, R17E, S.L.B.&M.
Duchesne County, UT.


DRAWN BY: C.H.M.
 DATE: 2-23-2011
 SCALE: 1" = 2,000'

TOPOGRAPHIC MAP

SHEET
D

WORKSHEET APPLICATION FOR PERMIT TO DRILL

APD RECEIVED: 10/26/2011**API NO. ASSIGNED:** 43013510260000**WELL NAME:** GMBU P-33-8-17**OPERATOR:** NEWFIELD PRODUCTION COMPANY (N2695)**PHONE NUMBER:** 435 646-4825**CONTACT:** Mandie Crozier**PROPOSED LOCATION:** NESE 32 080S 170E**Permit Tech Review:** ☒**SURFACE:** 2073 FSL 0911 FEL**Engineering Review:** ☐**BOTTOM:** 1057 FSL 0270 FWL**Geology Review:** ☒**COUNTY:** DUCHESNE**LATITUDE:** 40.07282**LONGITUDE:** -110.02416**UTM SURF EASTINGS:** 583210.00**NORTHINGS:** 4436296.00**FIELD NAME:** MONUMENT BUTTE**LEASE TYPE:** 1 - Federal**LEASE NUMBER:** UTU-77234**PROPOSED PRODUCING FORMATION(S):** GREEN RIVER**SURFACE OWNER:** 1 - Federal**COALBED METHANE:** NO**RECEIVED AND/OR REVIEWED:**☒ **PLAT**☒ **Bond:** FEDERAL - WYB000493☐ **Potash**☐ **Oil Shale 190-5**☐ **Oil Shale 190-3**☐ **Oil Shale 190-13**☒ **Water Permit:** 437478☐ **RDCC Review:**☐ **Fee Surface Agreement**☐ **Intent to Commingle****Commingle Approved****LOCATION AND SITING:**☐ **R649-2-3.****Unit:** GMBU (GRRV)☐ **R649-3-2. General**☐ **R649-3-3. Exception**☒ **Drilling Unit****Board Cause No:** Cause 213-11**Effective Date:** 11/30/2009**Siting:** Suspends General Siting☒ **R649-3-11. Directional Drill****Comments:** Presite Completed**Stipulations:** 4 - Federal Approval - dmason
15 - Directional - dmason
27 - Other - bhill**RECEIVED: November 08, 2011**

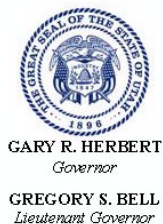

State of Utah

DEPARTMENT OF NATURAL RESOURCES

MICHAEL R. STYLER
Executive Director

Division of Oil, Gas and Mining

JOHN R. BAZA
Division Director

Permit To Drill

Well Name: GMBU P-33-8-17
API Well Number: 43013510260000
Lease Number: UTU-77234
Surface Owner: FEDERAL
Approval Date: 11/8/2011

Issued to:

NEWFIELD PRODUCTION COMPANY , Rt 3 Box 3630 , Myton, UT 84052

Authority:

Pursuant to Utah Code Ann. §40-6-1 et seq., and Utah Administrative Code R649-3-1 et seq., the Utah Division of Oil, Gas and Mining issues conditions of approval, and permit to drill the listed well. This permit is issued in accordance with the requirements of Cause 213-11. The expected producing formation or pool is the GREEN RIVER Formation(s), completion into any other zones will require filing a Sundry Notice (Form 9). Completion and commingling of more than one pool will require approval in accordance with R649-3-22.

Duration:

This approval shall expire one year from the above date unless substantial and continuous operation is underway, or a request for extension is made prior to the expiration date

General:

Compliance with the requirements of Utah Admin. R. 649-1 et seq., the Oil and Gas Conservation General Rules, and the applicable terms and provisions of the approved Application for permit to drill.

Conditions of Approval:

State approval of this well does not supercede the required federal approval, which must be obtained prior to drilling.

In accordance with Utah Admin. R.649-3-11, Directional Drilling, the operator shall submit a complete angular deviation and directional survey report to the Division within 30 days following completion of the well.

Production casing cement shall be brought up to or above the top of the unitized interval for the Greater Monument Butte Unit (Cause No. 213-11).

Notification Requirements:

The operator is required to notify the Division of Oil, Gas and Mining of the following actions during drilling of this well:

- Within 24 hours following the spudding of the well – contact Carol Daniels at 801-538-5284 (please leave a voicemail message if not available)
OR
submit an electronic sundry notice (pre-registration required) via the Utah Oil & Gas website at <http://oilgas.ogm.utah.gov>

Reporting Requirements:

All reports, forms and submittals as required by the Utah Oil and Gas Conservation General Rules will be promptly filed with the Division of Oil, Gas and Mining, including but not limited to:

- Entity Action Form (Form 6) – due within 5 days of spudding the well
- Monthly Status Report (Form 9) – due by 5th day of the following calendar month
- Requests to Change Plans (Form 9) – due prior to implementation
- Written Notice of Emergency Changes (Form 9) – due within 5 days
- Notice of Operations Suspension or Resumption (Form 9) – due prior to implementation
- Report of Water Encountered (Form 7) – due within 30 days after completion
- Well Completion Report (Form 8) – due within 30 days after completion or plugging

Approved By:

A handwritten signature in black ink, appearing to read "John Rogers", written over a horizontal line.

For John Rogers
Associate Director, Oil & Gas

UNITED STATES
DEPARTMENT OF THE INTERIOR
BUREAU OF LAND MANAGEMENT

RECEIVED

OCT 23 2011

FORM APPROVED
OMB No. 1004-0136
Expires July 31, 2010

APPLICATION FOR PERMIT TO DRILL OR REENTER

1a. Type of Work: <input checked="" type="checkbox"/> DRILL <input type="checkbox"/> REENTER		5. Lease Serial No. UTU77234
1b. Type of Well: <input checked="" type="checkbox"/> Oil Well <input type="checkbox"/> Gas Well <input type="checkbox"/> Other <input checked="" type="checkbox"/> Single Zone <input type="checkbox"/> Multiple Zone		6. If Indian, Allottee or Tribe Name
2. Name of Operator NEWFIELD PRODUCTION COMPANY Contact: MANDIE CROZIER Email: mcrozier@newfield.com		7. If Unit or CA Agreement, Name and No. GREATER MONUMENT
3a. Address ROUTE #3 BOX 3630 MYTON, UT 84052		8. Lease Name and Well No. GMBU P-33-8-17
3b. Phone No. (include area code) Ph: 435-646-4825 Fx: 435-646-3031		9. API Well No. 13 013-51026
4. Location of Well (Report location clearly and in accordance with any State requirements. *) At surface NESE 2073FSL 991FEL At proposed prod. zone SWSW 1057FSL 270FW		10. Field and Pool, or Exploratory MONUMENT BUTTE
14. Distance in miles and direction from nearest town or post office* 11.3		11. Sec., T., R., M., or Blk. and Survey or Area Sec 32 T8S R17E Mer SLB
15. Distance from proposed location to nearest property or lease line, ft. (Also to nearest drig. unit line, if any) 270'	16. No. of Acres in Lease 480.00	12. County or Parish DUCHESNE
18. Distance from proposed location to nearest well, drilling, completed, applied for, on this lease, ft. 1480'	19. Proposed Depth 6469 MD 6225 TVD	13. State UT
21. Elevations (Show whether DF, KB, RT, GL, etc.) 5192 GL	22. Approximate date work will start 03/31/2012	17. Spacing Unit dedicated to this well 20.00
		20. BLM/BIA Bond No. on file WYB000493
		23. Estimated duration 7 DAYS

24. Attachments

The following, completed in accordance with the requirements of Onshore Oil and Gas Order No. 1, shall be attached to this form:

- Well plat certified by a registered surveyor.
- A Drilling Plan.
- A Surface Use Plan (if the location is on National Forest System Lands, the SUPO shall be filed with the appropriate Forest Service Office).
- Bond to cover the operations unless covered by an existing bond on file (see Item 20 above).
- Operator certification.
- Such other site specific information and/or plans as may be required by the authorized officer.

25. Signature (Electronic Submission)	Name (Printed/Typed) MANDIE CROZIER Ph: 435-646-4825	Date 10/26/2011
Title REGULATORY ANALYST		
Approved by (Signature)	Name (Printed/Typed) Jerry Kenczka	Date MAY 08 2012
Title Assistant Field Manager Lands & Mineral Resources	Office VERNAL FIELD OFFICE	

Application approval does not warrant or certify the applicant holds legal or equitable title to those rights in the subject lease which would entitle the applicant to conduct operations thereon.
Conditions of approval, if any, are attached.

Title 18 U.S.C. Section 1001 and Title 43 U.S.C. Section 1212, make it a crime for any person knowingly and willfully to make to any department or agency of the United States any false, fictitious or fraudulent statements or representations as to any matter within its jurisdiction.

Additional Operator Remarks (see next page)

UDOGM

Electronic Submission #121407 verified by the BLM Well Information System
For NEWFIELD PRODUCTION COMPANY, sent to the Vernal
Committed to AFMSS for processing by LESLIE ROBINSON on 10/31/2011 ()

NOTICE OF APPROVAL
CONDITIONS OF APPROVAL ATTACHED

** OPERATOR-SUBMITTED ** OPERATOR-SUBMITTED ** OPERATOR-SUBMITTED **

115X50829A

NOV 8/22/11

RECEIVED

MAY 15 2012

DIV. OF OIL, GAS & MINING



UNITED STATES DEPARTMENT OF THE INTERIOR
BUREAU OF LAND MANAGEMENT
VERNAL FIELD OFFICE

170 South 500 East

VERNAL, UT 84078

(435) 781-4400



CONDITIONS OF APPROVAL FOR APPLICATION FOR PERMIT TO DRILL

Company: Newfield Production Company
Well No: GMBU P-33-8-17
API No: 43-013-51026

Location: NESE, Sec. 32, T8S R17E
Lease No: UTU-77234
Agreement: GMBU

OFFICE NUMBER: (435) 781-4400

OFFICE FAX NUMBER: (435) 781-3420

**A COPY OF THESE CONDITIONS SHALL BE FURNISHED TO YOUR
FIELD REPRESENTATIVE TO INSURE COMPLIANCE**

All lease and/or unit operations are to be conducted in such a manner that full compliance is made with the applicable laws, regulations (43 CFR Part 3160), and this approved Application for Permit to Drill including Surface and Downhole Conditions of Approval. The operator is considered fully responsible for the actions of his subcontractors. A copy of the approved APD must be on location during construction, drilling, and completion operations. **This permit is approved for a two (2) year period, or until lease expiration, whichever occurs first. An additional extension, up to two (2) years, may be applied for by sundry notice prior to expiration.**

NOTIFICATION REQUIREMENTS

Location Construction (Notify Environmental Scientist)	- Forty-Eight (48) hours prior to construction of location and access roads.
Location Completion (Notify Environmental Scientist)	- Prior to moving on the drilling rig.
Spud Notice (Notify Petroleum Engineer)	- Twenty-Four (24) hours prior to spudding the well.
Casing String & Cementing (Notify Supv. Petroleum Tech.)	- Twenty-Four (24) hours prior to running casing and cementing all casing strings to: blm_ut_vn_opreport@blm.gov
BOP & Related Equipment Tests (Notify Supv. Petroleum Tech.)	- Twenty-Four (24) hours prior to initiating pressure tests.
First Production Notice (Notify Petroleum Engineer)	- Within Five (5) business days after new well begins or production resumes after well has been off production for more than ninety (90) days.

**SURFACE USE PROGRAM
CONDITIONS OF APPROVAL (COAs)**

- All new and replacement internal combustion gas field engines of less than or equal to 300 design-rated horsepower must not emit more than 2 gms of NO_x per horsepower-hour. This requirement does not apply to gas field engines of less than or equal to 40 design-rated horsepower.
- All and replacement internal combustion gas field engines of greater than 300 design rated horsepower must not emit more than 1.0 gms of NO_x per horsepower-hour.
- If there is an active Gilsonite mining operation within 2 miles of the well location, operator shall notify the Gilsonite operator at least 48 hours prior to any blasting during construction.
- If paleontological materials are uncovered during construction, the operator is to immediately stop work and contact the Authorized Officer (AO). A determination will be made by the AO as to what mitigation may be necessary for the discovered paleontologic material before construction can continue.

SITE SPECIFIC COA's

THIS IS ON STATE SURFACE; THEREFORE, THESE ARE THE BLM'S RECOMMENDATIONS.

Wildlife

- The proposed project is within **mountain plover habitat**. If drilling or construction is proposed from May 1 to June 15, then a survey will be conducted by a qualified biologist. Permission to proceed may be granted in accordance with the "USFWS Mountain Plover Survey Guidelines" (March 2002) protocol. It is recommended that reclamation seed mixtures use low growing grasses and forbs.
- The proposed project is within 0.25 mile of a **great-horned owl nest**. If drilling or construction is proposed from February 1 to September 31, then a nest survey will be conducted by a qualified biologist. If it is determined that the nest is inactive, then permission to proceed may be granted by the BLM Authorized Officer. If the nest is determined to be active, then the timing restriction will remain in effect.

Air Quality

- All internal combustion equipment will be kept in good working order.
- Water or other approved dust suppressants will be used at construction sites and along roads, as determined appropriate by the Authorized Officer.
- Open burning of garbage or refuse will not occur at well sites or other facilities.
- Low bleed pneumatics will be installed on separator dump valves and other controllers.
- During completion, flaring will be limited as much as possible. Production equipment and gathering lines will be installed as soon as possible.
- Well site telemetry will be utilized as feasible for production operations.

S.O.P.s

- After cessation of drilling and completion operations, any visible or measurable layer of oil must be removed from the surface of the reserve pit and the pit kept free of oil.
- Pits must be free of oil and other liquid and solid wastes prior to filling. Pit liners must not be breached (cut) or filled (squeezed) while still containing fluids. The pit liner must be removed to the solids level or treated to prevent its reemergence to the surface or its interference with long-term successful revegetation.
- All operator employees and/or authorized personnel (sub-contractors) in the field will have approved applicable APD's, ROW, COAs permits/authorizations on their person(s) during all phases of construction.

Reclamation

- Reclamation will be completed in accordance with the Newfield Exploration Company Castle Peak and Eight Mile Flat Reclamation Plan on file with the Vernal Field Office of the BLM, so that disturbance is returned as close to a natural state as possible..
- Appropriate erosion control and revegetation measures will be employed. In areas with unstable soils where seeding alone may not adequately control erosion, grading will be used to minimize slopes and water bars will be installed on disturbed slopes. Erosion control efforts will be monitored by Newfield and, if necessary, modifications will be made to control erosion.

Monitoring and Reporting

- The operator shall submit a Sundry Notice (Form 3160-5) to the BLM Authorized Officer (AO) that designates the proposed site-specific monitoring and reference sites chosen for the location. A description of the proposed sites shall be included, as well as a map showing the locations of the proposed sites.
- The operator shall submit a Sundry Notice (Form 3160-5) to the BLM Authorized Officer (AO) 3 growing seasons after reclamation efforts have occurred evaluating the status of the reclaimed areas in order to determine whether the BLM standards set forth in the Green River District Reclamation Guidelines have been met (30% or greater basal cover).

**DOWNHOLE PROGRAM
CONDITIONS OF APPROVAL (COAs)**

SITE SPECIFIC DOWNHOLE COAs:

- Newfield Production Co. shall comply with all applicable requirements in the SOP (version: "Greater Monument Butte Green River Development Program", June 24, 2008). The operator shall also comply with applicable laws and regulations; with lease terms, Onshore Oil and Gas Orders, NTL's; and with other orders and instructions of the authorized officer.

All provisions outlined in Onshore Oil & Gas Order #2 Drilling Operations shall be strictly adhered to. The following items are emphasized:

DRILLING/COMPLETION/PRODUCING OPERATING STANDARDS

- The spud date and time shall be reported orally to Vernal Field Office within 24 hours of spudding.
- Notify Vernal Field Office Supervisory Petroleum Engineering Technician at least 24 hours in advance of casing cementing operations and BOPE & casing pressure tests.
- All requirements listed in Onshore Order #2 III. E. Special Drilling Operations are applicable for air drilling of surface hole.
- Blowout prevention equipment (BOPE) shall remain in use until the well is completed or abandoned. Closing unit controls shall remain unobstructed and readily accessible at all times. Choke manifolds shall be located outside of the rig substructure.
- All BOPE components shall be inspected daily and those inspections shall be recorded in the daily drilling report. Components shall be operated and tested as required by Onshore Oil & Gas Order No. 2 to insure good mechanical working order. All BOPE pressure tests shall be performed by a test pump with a chart recorder and **NOT** by the rig pumps. Test shall be reported in the driller's log.
- BOP drills shall be initially conducted by each drilling crew within 24 hours of drilling out from under the surface casing and weekly thereafter as specified in Onshore Oil & Gas Order No. 2.
- Casing pressure tests are required before drilling out from under all casing strings set and cemented in place.
- No aggressive/fresh hard-banded drill pipe shall be used within casing.
- **Cement baskets shall not be run on surface casing.**
- The operator must report all shows of water or water-bearing sands to the BLM. If flowing water is encountered it must be sampled, analyzed, and a copy of the analyses submitted to the BLM Vernal Field Office.
- The operator must report encounters of all non oil & gas mineral resources (such as Gilsonite, tar sands, oil shale, trona, etc.) to the Vernal Field Office, in writing, within 5 working days of each encounter. Each report shall include the well name/number, well location, date and depth (from KB

or GL) of encounter, vertical footage of the encounter and, the name of the person making the report (along with a telephone number) should the BLM need to obtain additional information.

- A complete set of angular deviation and directional surveys of a directional well will be submitted to the Vernal BLM office engineer within 30 days of the completion of the well.
- While actively drilling, chronologic drilling progress reports shall be filed directly with the BLM, Vernal Field Office on a weekly basis in sundry, letter format or e-mail to the Petroleum Engineers until the well is completed.
- A cement bond log (CBL) will be run from the production casing shoe to the top of cement and shall be utilized to determine the bond quality for the production casing. Submit a field copy of the CBL to this office.
- **Please submit an electronic copy of all other logs run on this well in LAS format to BLM_UT_VN_Welllogs@BLM.gov. This submission will supersede the requirement for submittal of paper logs to the BLM.**
- There shall be no deviation from the proposed drilling, completion, and/or workover program as approved. Safe drilling and operating practices must be observed. Any changes in operation must have prior approval from the BLM Vernal Field Office.

OPERATING REQUIREMENT REMINDERS:

- All wells, whether drilling, producing, suspended, or abandoned, shall be identified in accordance with 43 CFR 3162.6. There shall be a sign or marker with the name of the operator, lease serial number, well number, and surveyed description of the well.
- For information regarding production reporting, contact the Office of Natural Resources Revenue (ONRR) at www.ONRR.gov.
- In accordance with 43 CFR 3162.4-3, this well shall be reported on the "Monthly Report of Operations" (Oil and Gas Operations Report ((OGOR)) starting with the month in which operations commence and continue each month until the well is physically plugged and abandoned. This report shall be filed in duplicate, directly with the Minerals Management Service, P.O. Box 17110, Denver, Colorado 80217-0110, or call 1-800-525-7922 (303) 231-3650 for reporting information.
- Should the well be successfully completed for production, the BLM Vernal Field office must be notified when it is placed in a producing status. Such notification will be by written communication and must be received in this office by not later than the fifth business day following the date on which the well is placed on production. The notification shall provide, as a minimum, the following informational items:
 - Operator name, address, and telephone number.
 - Well name and number.
 - Well location (¼¼, Sec., Twn, Rng, and P.M.).
 - Date well was placed in a producing status (date of first production for which royalty will be paid).
 - The nature of the well's production, (i.e., crude oil, or crude oil and casing head gas, or natural gas and entrained liquid hydrocarbons).
 - The Federal or Indian lease prefix and number on which the well is located; otherwise the non-Federal or non-Indian land category, i.e., State or private.
 - Unit agreement and/or participating area name and number, if applicable.
 - Communitization agreement number, if applicable.
- Any venting or flaring of gas shall be done in accordance with Notice to Lessees (NTL) 4A and needs prior approval from the BLM Vernal Field Office.
- All undesirable events (fires, accidents, blowouts, spills, discharges) as specified in NTL 3A will be reported to the BLM, Vernal Field Office. Major events, as defined in NTL3A, shall be reported verbally within 24 hours, followed by a written report within 15 days. "Other than Major Events" will be reported in writing within 15 days. "Minor Events" will be reported on the Monthly Report of Operations and Production.
- Whether the well is completed as a dry hole or as a producer, "Well Completion and Recompletion Report and Log" (BLM Form 3160-4) shall be submitted not later than 30 days after completion of the well or after completion of operations being performed, in accordance with 43 CFR 3162.4-1.

Two copies of all logs run, core descriptions, and all other surveys or data obtained and compiled during the drilling, workover, and/or completion operations, shall be filed on BLM Form 3160-4. Submit with the well completion report a geologic report including, at a minimum, formation tops, and a summary and conclusions. Also include deviation surveys, sample descriptions, strip logs, core data, drill stem test data, and results of production tests if performed. Samples (cuttings, fluid, and/or gas) shall be submitted only when requested by the BLM, Vernal Field Office.

- All off-lease storage, off-lease measurement, or commingling on-lease or off-lease, shall have prior written approval from the BLM Vernal Field Office.
- Oil and gas meters shall be calibrated in place prior to any deliveries. The BLM Vernal Field Office Petroleum Engineers will be provided with a date and time for the initial meter calibration and all future meter proving schedules. A copy of the meter calibration reports shall be submitted to the BLM Vernal Field Office. All measurement facilities will conform to the API standards for liquid hydrocarbons and the AGA standards for natural gas measurement. All measurement points shall be identified as the point of sale or allocation for royalty purposes.
- A schematic facilities diagram as required by Onshore Oil & Gas Order No. 3 shall be submitted to the BLM Vernal Field Office within 30 days of installation or first production, whichever occurs first. All site security regulations as specified in Onshore Oil & Gas Order No. 3 shall be adhered to. All product lines entering and leaving hydrocarbon storage tanks will be effectively sealed in accordance with Onshore Oil & Gas Order No. 3.
- Any additional construction, reconstruction, or alterations of facilities, including roads, gathering lines, batteries, etc., which will result in the disturbance of new ground, shall require the filing of a suitable plan and need prior approval of the BLM Vernal Field Office. Emergency approval may be obtained orally, but such approval does not waive the written report requirement.
- No location shall be constructed or moved, no well shall be plugged, and no drilling or workover equipment shall be removed from a well to be placed in a suspended status without prior approval of the BLM Vernal Field Office. If operations are to be suspended for more than 30 days, prior approval of the BLM Vernal Field Office shall be obtained and notification given before resumption of operations.
- Pursuant to Onshore Oil & Gas Order No. 7, this is authorization for pit disposal of water produced from this well for a period of 90 days from the date of initial production. A permanent disposal method must be approved by this office and in operation prior to the end of this 90-day period. In order to meet this deadline, an application for the proposed permanent disposal method shall be submitted along with any necessary water analyses, as soon as possible, but no later than 45 days after the date of first production. Any method of disposal which has not been approved prior to the end of the authorized 90-day period will be considered as an Incident of Noncompliance and will be grounds for issuing a shut-in order until an acceptable manner for disposing of said water is provided and approved by this office.
- Unless the plugging is to take place immediately upon receipt of oral approval, the Field Office Petroleum Engineers must be notified at least 24 hours in advance of the plugging of the well, in order that a representative may witness plugging operations. If a well is suspended or abandoned, all pits must be fenced immediately until they are backfilled. The "Subsequent Report of Abandonment" (Form BLM 3160-5) must be submitted within 30 days after the actual plugging of the well bore, showing location of plugs, amount of cement in each, and amount of casing left in hole, and the current status of the surface restoration.

STATE OF UTAH DEPARTMENT OF NATURAL RESOURCES DIVISION OF OIL, GAS, AND MINING		FORM 9
SUNDRY NOTICES AND REPORTS ON WELLS Do not use this form for proposals to drill new wells, significantly deepen existing wells below current bottom-hole depth, reenter plugged wells, or to drill horizontal laterals. Use APPLICATION FOR PERMIT TO DRILL form for such proposals.		5. LEASE DESIGNATION AND SERIAL NUMBER: UTU-77234
1. TYPE OF WELL Oil Well		6. IF INDIAN, ALLOTTEE OR TRIBE NAME:
2. NAME OF OPERATOR: NEWFIELD PRODUCTION COMPANY		7. UNIT or CA AGREEMENT NAME: GMBU (GRRV)
3. ADDRESS OF OPERATOR: Rt 3 Box 3630 , Myton, UT, 84052		8. WELL NAME and NUMBER: GMBU P-33-8-17
4. LOCATION OF WELL FOOTAGES AT SURFACE: 2073 FSL 0911 FEL QTR/QTR, SECTION, TOWNSHIP, RANGE, MERIDIAN: Qtr/Qtr: NESE Section: 32 Township: 08.0S Range: 17.0E Meridian: S		9. API NUMBER: 43013510260000
PHONE NUMBER: 435 646-4825 Ext		9. FIELD and POOL or WILDCAT: MONUMENT BUTTE
COUNTY: DUCHESNE		STATE: UTAH
11. CHECK APPROPRIATE BOXES TO INDICATE NATURE OF NOTICE, REPORT, OR OTHER DATA		
TYPE OF SUBMISSION	TYPE OF ACTION	
<input checked="" type="checkbox"/> NOTICE OF INTENT Approximate date work will start: 11/8/2012 <input type="checkbox"/> SUBSEQUENT REPORT Date of Work Completion: <input type="checkbox"/> SPUD REPORT Date of Spud: <input type="checkbox"/> DRILLING REPORT Report Date:	<div style="display: flex; flex-wrap: wrap;"> <div style="width: 33%;"> <input type="checkbox"/> ACIDIZE <input type="checkbox"/> CHANGE TO PREVIOUS PLANS <input type="checkbox"/> CHANGE WELL STATUS <input type="checkbox"/> DEEPEN <input type="checkbox"/> OPERATOR CHANGE <input type="checkbox"/> PRODUCTION START OR RESUME <input type="checkbox"/> REPERFORATE CURRENT FORMATION <input type="checkbox"/> TUBING REPAIR <input type="checkbox"/> WATER SHUTOFF <input type="checkbox"/> WILDCAT WELL DETERMINATION </div> <div style="width: 33%;"> <input type="checkbox"/> ALTER CASING <input type="checkbox"/> CHANGE TUBING <input type="checkbox"/> COMMINGLE PRODUCING FORMATIONS <input type="checkbox"/> FRACTURE TREAT <input type="checkbox"/> PLUG AND ABANDON <input type="checkbox"/> RECLAMATION OF WELL SITE <input type="checkbox"/> SIDETRACK TO REPAIR WELL <input type="checkbox"/> VENT OR FLARE <input type="checkbox"/> SI TA STATUS EXTENSION <input type="checkbox"/> OTHER </div> <div style="width: 33%;"> <input type="checkbox"/> CASING REPAIR <input type="checkbox"/> CHANGE WELL NAME <input type="checkbox"/> CONVERT WELL TYPE <input type="checkbox"/> NEW CONSTRUCTION <input type="checkbox"/> PLUG BACK <input type="checkbox"/> RECOMPLETE DIFFERENT FORMATION <input type="checkbox"/> TEMPORARY ABANDON <input type="checkbox"/> WATER DISPOSAL <input checked="" type="checkbox"/> APD EXTENSION OTHER: <input style="width: 100px;" type="text"/> </div> </div>	
12. DESCRIBE PROPOSED OR COMPLETED OPERATIONS. Clearly show all pertinent details including dates, depths, volumes, etc. Newfield proposes to extend the Application for Permit to Drill for one year.		
<div style="text-align: right;"> Approved by the Utah Division of Oil, Gas and Mining Date: <u>October 11, 2012</u> By: </div>		
NAME (PLEASE PRINT) Mandie Crozier		PHONE NUMBER 435 646-4825
SIGNATURE N/A		TITLE Regulatory Tech DATE 10/9/2012



The Utah Division of Oil, Gas, and Mining

- State of Utah
- Department of Natural Resources

Electronic Permitting System - Sundry Notices

Request for Permit Extension Validation Well Number 43013510260000

API: 43013510260000

Well Name: GMBU P-33-8-17

Location: 2073 FSL 0911 FEL QTR NESE SEC 32 TWNP 080S RNG 170E MER S

Company Permit Issued to: NEWFIELD PRODUCTION COMPANY

Date Original Permit Issued: 11/8/2011


The undersigned as owner with legal rights to drill on the property as permitted above, hereby verifies that the information as submitted in the previously approved application to drill, remains valid and does not require revision. Following is a checklist of some items related to the application, which should be verified.

- If located on private land, has the ownership changed, if so, has the surface agreement been updated? ☒ Yes ☐ No
- Have any wells been drilled in the vicinity of the proposed well which would affect the spacing or siting requirements for this location? ☐ Yes ☒ No
- Has there been any unit or other agreements put in place that could affect the permitting or operation of this proposed well? ☐ Yes ☒ No
- Have there been any changes to the access route including ownership, or rightof- way, which could affect the proposed location? ☐ Yes ☒ No
- Has the approved source of water for drilling changed? ☐ Yes ☒ No
- Have there been any physical changes to the surface location or access route which will require a change in plans from what was discussed at the onsite evaluation? ☐ Yes ☒ No
- Is bonding still in place, which covers this proposed well? ☒ Yes ☐ No

Signature: Mandie Crozier

Date: 10/9/2012

Title: Regulatory Tech **Representing:** NEWFIELD PRODUCTION COMPANY

STATE OF UTAH DEPARTMENT OF NATURAL RESOURCES DIVISION OF OIL, GAS, AND MINING		FORM 9
SUNDRY NOTICES AND REPORTS ON WELLS Do not use this form for proposals to drill new wells, significantly deepen existing wells below current bottom-hole depth, reenter plugged wells, or to drill horizontal laterals. Use APPLICATION FOR PERMIT TO DRILL form for such proposals.		5. LEASE DESIGNATION AND SERIAL NUMBER: UTU-77234
1. TYPE OF WELL Oil Well		6. IF INDIAN, ALLOTTEE OR TRIBE NAME:
2. NAME OF OPERATOR: NEWFIELD PRODUCTION COMPANY		7. UNIT or CA AGREEMENT NAME: GMBU (GRRV)
3. ADDRESS OF OPERATOR: Rt 3 Box 3630 , Myton, UT, 84052		8. WELL NAME and NUMBER: GMBU P-33-8-17
4. LOCATION OF WELL FOOTAGES AT SURFACE: 2073 FSL 0911 FEL QTR/QTR, SECTION, TOWNSHIP, RANGE, MERIDIAN: Qtr/Qtr: NESE Section: 32 Township: 08.0S Range: 17.0E Meridian: S		9. API NUMBER: 43013510260000
PHONE NUMBER: 435 646-4825 Ext		9. FIELD and POOL or WILDCAT: MONUMENT BUTTE
COUNTY: DUCHESNE		STATE: UTAH
11. CHECK APPROPRIATE BOXES TO INDICATE NATURE OF NOTICE, REPORT, OR OTHER DATA		
TYPE OF SUBMISSION	TYPE OF ACTION	
<input checked="" type="checkbox"/> NOTICE OF INTENT Approximate date work will start: 11/8/2013 <input type="checkbox"/> SUBSEQUENT REPORT Date of Work Completion: <input type="checkbox"/> SPUD REPORT Date of Spud: <input type="checkbox"/> DRILLING REPORT Report Date:	<div style="display: flex; flex-wrap: wrap;"> <div style="width: 33%;"> <input type="checkbox"/> ACIDIZE <input type="checkbox"/> CHANGE TO PREVIOUS PLANS <input type="checkbox"/> CHANGE WELL STATUS <input type="checkbox"/> DEEPEN <input type="checkbox"/> OPERATOR CHANGE <input type="checkbox"/> PRODUCTION START OR RESUME <input type="checkbox"/> REPERFORATE CURRENT FORMATION <input type="checkbox"/> TUBING REPAIR <input type="checkbox"/> WATER SHUTOFF <input type="checkbox"/> WILDCAT WELL DETERMINATION </div> <div style="width: 33%;"> <input type="checkbox"/> ALTER CASING <input type="checkbox"/> CHANGE TUBING <input type="checkbox"/> COMMINGLE PRODUCING FORMATIONS <input type="checkbox"/> FRACTURE TREAT <input type="checkbox"/> PLUG AND ABANDON <input type="checkbox"/> RECLAMATION OF WELL SITE <input type="checkbox"/> SIDETRACK TO REPAIR WELL <input type="checkbox"/> VENT OR FLARE <input type="checkbox"/> SI TA STATUS EXTENSION <input type="checkbox"/> OTHER </div> <div style="width: 33%;"> <input type="checkbox"/> CASING REPAIR <input type="checkbox"/> CHANGE WELL NAME <input type="checkbox"/> CONVERT WELL TYPE <input type="checkbox"/> NEW CONSTRUCTION <input type="checkbox"/> PLUG BACK <input type="checkbox"/> RECOMPLETE DIFFERENT FORMATION <input type="checkbox"/> TEMPORARY ABANDON <input type="checkbox"/> WATER DISPOSAL <input checked="" type="checkbox"/> APD EXTENSION OTHER: <input style="width: 100px;" type="text"/> </div> </div>	
12. DESCRIBE PROPOSED OR COMPLETED OPERATIONS. Clearly show all pertinent details including dates, depths, volumes, etc. Newfield proposes to extend the Application for Permit to Drill this well.		
Approved by the Utah Division of Oil, Gas and Mining Date: <u>October 16, 2013</u> By: <u></u>		
NAME (PLEASE PRINT) Mandie Crozier		PHONE NUMBER 435 646-4825
SIGNATURE N/A		TITLE Regulatory Tech DATE 10/9/2013



The Utah Division of Oil, Gas, and Mining

- State of Utah
- Department of Natural Resources

Electronic Permitting System - Sundry Notices

Request for Permit Extension Validation Well Number 43013510260000

API: 43013510260000

Well Name: GMBU P-33-8-17

Location: 2073 FSL 0911 FEL QTR NESE SEC 32 TWNP 080S RNG 170E MER S

Company Permit Issued to: NEWFIELD PRODUCTION COMPANY

Date Original Permit Issued: 11/8/2011

The undersigned as owner with legal rights to drill on the property as permitted above, hereby verifies that the information as submitted in the previously approved application to drill, remains valid and does not require revision. Following is a checklist of some items related to the application, which should be verified.

- If located on private land, has the ownership changed, if so, has the surface agreement been updated? ☒ Yes ☐ No
- Have any wells been drilled in the vicinity of the proposed well which would affect the spacing or siting requirements for this location? ☐ Yes ☒ No
- Has there been any unit or other agreements put in place that could affect the permitting or operation of this proposed well? ☐ Yes ☒ No
- Have there been any changes to the access route including ownership, or rightof- way, which could affect the proposed location? ☐ Yes ☒ No
- Has the approved source of water for drilling changed? ☐ Yes ☒ No
- Have there been any physical changes to the surface location or access route which will require a change in plans from what was discussed at the onsite evaluation? ☐ Yes ☒ No
- Is bonding still in place, which covers this proposed well? ☒ Yes ☐ No

Signature: Mandie Crozier

Date: 10/9/2013

Title: Regulatory Tech **Representing:** NEWFIELD PRODUCTION COMPANY

STATE OF UTAH DEPARTMENT OF NATURAL RESOURCES DIVISION OF OIL, GAS, AND MINING		FORM 9
SUNDRY NOTICES AND REPORTS ON WELLS Do not use this form for proposals to drill new wells, significantly deepen existing wells below current bottom-hole depth, reenter plugged wells, or to drill horizontal laterals. Use APPLICATION FOR PERMIT TO DRILL form for such proposals.		5. LEASE DESIGNATION AND SERIAL NUMBER: UTU-77234
1. TYPE OF WELL Oil Well		6. IF INDIAN, ALLOTTEE OR TRIBE NAME:
2. NAME OF OPERATOR: NEWFIELD PRODUCTION COMPANY		7. UNIT or CA AGREEMENT NAME: GMBU (GRRV)
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4. LOCATION OF WELL FOOTAGES AT SURFACE: 2073 FSL 0911 FEL QTR/QTR, SECTION, TOWNSHIP, RANGE, MERIDIAN: Qtr/Qtr: NESE Section: 32 Township: 08.0S Range: 17.0E Meridian: S		9. API NUMBER: 43013510260000
PHONE NUMBER: 435 646-4825 Ext		9. FIELD and POOL or WILDCAT: MONUMENT BUTTE
COUNTY: DUCHESNE		STATE: UTAH
11. CHECK APPROPRIATE BOXES TO INDICATE NATURE OF NOTICE, REPORT, OR OTHER DATA		
TYPE OF SUBMISSION	TYPE OF ACTION	
<input type="checkbox"/> NOTICE OF INTENT Approximate date work will start:	<input type="checkbox"/> ACIDIZE	
<input type="checkbox"/> SUBSEQUENT REPORT Date of Work Completion:	<input type="checkbox"/> ALTER CASING	
<input checked="" type="checkbox"/> SPUD REPORT Date of Spud: 5/19/2014	<input type="checkbox"/> CASING REPAIR	
<input type="checkbox"/> DRILLING REPORT Report Date:	<input type="checkbox"/> CHANGE TO PREVIOUS PLANS	
	<input type="checkbox"/> CHANGE WELL STATUS	
	<input type="checkbox"/> CHANGE WELL NAME	
	<input type="checkbox"/> COMMINGLE PRODUCING FORMATIONS	
	<input type="checkbox"/> CONVERT WELL TYPE	
	<input type="checkbox"/> DEEPEN	
	<input type="checkbox"/> FRACTURE TREAT	
	<input type="checkbox"/> NEW CONSTRUCTION	
	<input type="checkbox"/> OPERATOR CHANGE	
	<input type="checkbox"/> PLUG AND ABANDON	
	<input type="checkbox"/> PLUG BACK	
	<input type="checkbox"/> PRODUCTION START OR RESUME	
	<input type="checkbox"/> RECLAMATION OF WELL SITE	
	<input type="checkbox"/> RECOMPLETE DIFFERENT FORMATION	
	<input type="checkbox"/> REPERFORATE CURRENT FORMATION	
	<input type="checkbox"/> SIDETRACK TO REPAIR WELL	
	<input type="checkbox"/> TEMPORARY ABANDON	
	<input type="checkbox"/> TUBING REPAIR	
	<input type="checkbox"/> VENT OR FLARE	
	<input type="checkbox"/> WATER DISPOSAL	
	<input type="checkbox"/> WATER SHUTOFF	
	<input type="checkbox"/> SI TA STATUS EXTENSION	
	<input type="checkbox"/> WILDCAT WELL DETERMINATION	
	<input type="checkbox"/> OTHER: <input style="width: 100px;" type="text"/>	
12. DESCRIBE PROPOSED OR COMPLETED OPERATIONS. Clearly show all pertinent details including dates, depths, volumes, etc. On 5/19/14 drill and set 4' of 14" conductor. Drill f/4' to 328'KB of 12 1/4" hole. P/U and run 7 joints of 8 5/8" casing set depth 321' KB. On 5/21/14 Cement w/Halliburton w/155 sx of 15.8 # 1.19 yield G Neat cement returned 5 bbls back to pit and bumped plug to 550 psi.		
Accepted by the Utah Division of Oil, Gas and Mining FOR RECORD ONLY May 28, 2014		
NAME (PLEASE PRINT) Cherei Neilson	PHONE NUMBER 435 646-4883	TITLE Drilling Technician
SIGNATURE N/A	DATE 5/28/2014	

NEWFIELD**Casing****Conductor**

Legal Well Name GMBU P-33-8-17		Wellbore Name Original Hole	
API/UWI 43013510260000	Surface Legal Location NESE 2073 FSL 991 FEL Sec 32 T8S R17E	Field Name GMBU CTB7	Well Type Development
Well RC 500323341	County Duchesne	State/Province Utah	Spud Date
		Final Rig Release Date	

Wellbore					
Wellbore Name Original Hole				Kick Off Depth (ftKB)	
Section Des	Size (in)	Actual Top Depth (MD) (ftKB)	Actual Bottom Depth (MD) (ftKB)	Start Date	End Date
Conductor	14	11	15	5/19/2014	5/19/2014

Wellhead			
Type	Install Date	Service	Comment

Wellhead Components				
Des	Make	Model	SN	WP Top (psi)

Casing			
Casing Description Conductor	Set Depth (ftKB) 15	Run Date 5/19/2014	Set Tension (kips)
Centralizers	Scratchers		

Casing Components												
Item Des	OD (in)	ID (in)	Wt (lb/ft)	Grade	Top Thread	Jts	Len (ft)	Top (ftKB)	Btm (ftKB)	Mk-up Tq (ft-lb)	Class	Max OD (in)
Conductor	14	13.500	36.75	H-40		1	4.00	11.0	15.0			

Jewelry Details							
External Casing Packer							
Type	Setting Requirement	Release Requirements			Inflation Method	Vol Inflation (gal)	Equiv Hole Sz (in)
Inflation Fluid Type	Infl FI Dens (lb/gal)	P AV Set (psi)	AV Acting Pressure (psi)	P ICV Set (psi)	P ICV Act (psi)	ECP Load (1000lbf)	Seal Load (1000lbf)

Slotted Liner							
% Open Area (%)	Perforation Min Dimension (in)	Perforation Max Dimension (in)	Axial Perf Spacing (ft)	Perf Rows	Blank Top Length (ft)	Blank Bottom Length (ft)	
Slot Description	Slot Pattern			Slot Length (in)	Slot Width (in)	Slot Frequency	Screen Gauge (ga)

Liner Hanger			
Retrievable?	Elastomer Type	Element Center Depth (ft)	Polish Bore Size (in)
Slip Description		Set Mechanics	

Setting Procedure
Unsetting Procedure

NEWFIELD**Casing****Surface**

Legal Well Name GMBU P-33-8-17		Wellbore Name Original Hole	
API/UWI 43013510260000	Surface Legal Location NESE 2073 FSL 991 FEL Sec 32 T8S R17E	Field Name GMBU CTB7	Well Type Development
Well RC 500323341	County Duchesne	State/Province Utah	Spud Date
		Final Rig Release Date	

Wellbore					
Wellbore Name Original Hole				Kick Off Depth (ftKB)	
Section Des	Size (in)	Actual Top Depth (MD) (ftKB)	Actual Bottom Depth (MD) (ftKB)	Start Date	End Date
Conductor	14	11	15	5/19/2014	5/19/2014
Vertical	12 1/4	15	328	5/19/2014	5/19/2014

Wellhead				
Type	Install Date	Service	Comment	

Wellhead Components				
Des	Make	Model	SN	WP Top (psi)

Casing				
Casing Description Surface	Set Depth (ftKB)	Run Date	Set Tension (kips)	
	321	5/19/2014		
Centralizers 3	Scratchers			

Casing Components												
Item Des	OD (in)	ID (in)	Wt (lb/ft)	Grade	Top Thread	Jts	Len (ft)	Top (ftKB)	Btm (ftKB)	Mk-up Tq (ft-lb)	Class	Max OD (in)
Wellhead	8 5/8	8.097	24.00	J-55	ST&C	1	2.30	11.1	13.4			
Cut Off	8 5/8	8.097	24.00	J-55	ST&C	1	42.02	13.4	55.4			
Casing Joints	8 5/8	8.097	24.00	J-55	ST&C	5	219.27	55.4	274.7			
Float Collar	8 5/8	8.097	24.00	J-55	ST&C	1	0.92	274.7	275.6			
Shoe Joint	8 5/8	8.097	24.00	J-55	ST&C	1	44.02	275.6	319.6			
Guide Shoe	8 5/8	8.097	24.00	J-55	ST&C	1	1.40	319.6	321.0			

Jewelry Details									
External Casing Packer									
Type	Setting Requirement	Release Requirements			Inflation Method	Vol Inflation (gal)	Equiv Hole Sz (in)		
Inflation Fluid Type	Infl Fl Dens (lb/gal)	P AV Set (psi)	AV Acting Pressure (psi)	P ICV Set (psi)	P ICV Act (psi)	ECP Load (1000lbf)	Seal Load (1000lbf)		

Slotted Liner							
% Open Area (%)	Perforation Min Dimension (in)	Perforation Max Dimension (in)	Axial Perf Spacing (ft)	Perf Rows	Blank Top Length (ft)	Blank Bottom Length (ft)	
Slot Description	Slot Pattern			Slot Length (in)	Slot Width (in)	Slot Frequency	Screen Gauge (ga)

Liner Hanger				
Retrievable?	Elastomer Type	Element Center Depth (ft)	Polish Bore Size (in)	Polish Bore Length (ft)
Slip Description			Set Mechanics	

Setting Procedure				
Unsetting Procedure				

BLM - Vernal Field Office - Notification Form

Operator Newfield Exploration Rig Name/# Ross 29 Submitted By
Branden Arnold Phone Number 435-401-0223

Well Name/Number GMBU P-33-8-17

Qtr/Qtr NE/SE Section 32 Township 8S Range 17E

Lease Serial Number UTU-77234

API Number 43-013-51026

Spud Notice – Spud is the initial spudding of the well, not drilling
out below a casing string.

Date/Time 5/19/14 8:00 AM ☐ PM ☐

Casing – Please report time casing run starts, not cementing
times.

- ☐ Surface Casing
- ☐ Intermediate Casing
- ☐ Production Casing
- ☐ Liner
- ☐ Other

Date/Time 5/19/14 3:00 AM ☐ PM ☐

BOPE

- ☐ Initial BOPE test at surface casing point
- ☐ BOPE test at intermediate casing point
- ☐ 30 day BOPE test
- ☐ Other

Date/Time _____ AM ☐ PM ☐

Remarks _____

STATE OF UTAH DEPARTMENT OF NATURAL RESOURCES DIVISION OF OIL, GAS, AND MINING		FORM 9
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PHONE NUMBER: 435 646-4825 Ext		9. FIELD and POOL or WILDCAT: MONUMENT BUTTE
COUNTY: DUCHESNE		STATE: UTAH
11. CHECK APPROPRIATE BOXES TO INDICATE NATURE OF NOTICE, REPORT, OR OTHER DATA		
TYPE OF SUBMISSION	TYPE OF ACTION	
<input type="checkbox"/> NOTICE OF INTENT Approximate date work will start:	<input type="checkbox"/> ACIDIZE	
<input type="checkbox"/> SUBSEQUENT REPORT Date of Work Completion:	<input type="checkbox"/> ALTER CASING	
<input type="checkbox"/> SPUD REPORT Date of Spud:	<input type="checkbox"/> CASING REPAIR	
<input checked="" type="checkbox"/> DRILLING REPORT Report Date: 6/24/2014	<input type="checkbox"/> CHANGE TO PREVIOUS PLANS	
	<input type="checkbox"/> CHANGE TUBING	
	<input type="checkbox"/> CHANGE WELL STATUS	
	<input type="checkbox"/> COMMINGLE PRODUCING FORMATIONS	
	<input type="checkbox"/> CONVERT WELL TYPE	
	<input type="checkbox"/> DEEPEN	
	<input type="checkbox"/> FRACTURE TREAT	
	<input type="checkbox"/> NEW CONSTRUCTION	
	<input type="checkbox"/> OPERATOR CHANGE	
	<input type="checkbox"/> PLUG AND ABANDON	
	<input type="checkbox"/> PLUG BACK	
	<input checked="" type="checkbox"/> PRODUCTION START OR RESUME	
	<input type="checkbox"/> RECLAMATION OF WELL SITE	
	<input type="checkbox"/> RECOMPLETE DIFFERENT FORMATION	
	<input type="checkbox"/> REPERFORATE CURRENT FORMATION	
	<input type="checkbox"/> SIDETRACK TO REPAIR WELL	
	<input type="checkbox"/> TEMPORARY ABANDON	
	<input type="checkbox"/> TUBING REPAIR	
	<input type="checkbox"/> VENT OR FLARE	
	<input type="checkbox"/> WATER DISPOSAL	
	<input type="checkbox"/> WATER SHUTOFF	
	<input type="checkbox"/> SI TA STATUS EXTENSION	
	<input type="checkbox"/> WILDCAT WELL DETERMINATION	
	<input type="checkbox"/> OTHER: <input style="width: 100px;" type="text"/>	
12. DESCRIBE PROPOSED OR COMPLETED OPERATIONS. Clearly show all pertinent details including dates, depths, volumes, etc. The above well was placed on production on 06/24/2014 at 14:00 hours.		
Accepted by the Utah Division of Oil, Gas and Mining FOR RECORD ONLY July 02, 2014		
NAME (PLEASE PRINT) Jennifer Peatross	PHONE NUMBER 435 646-4885	TITLE Production Technician
SIGNATURE N/A	DATE 7/2/2014	

Form 3160-4
(March 2012)UNITED STATES
DEPARTMENT OF THE INTERIOR
BUREAU OF LAND MANAGEMENTFORM APPROVED
OMB NO. 1004-0137
Expires: October 31, 2014

WELL COMPLETION OR RECOMPLETION REPORT AND LOG

1a. Type of Well <input checked="" type="checkbox"/> Oil Well <input type="checkbox"/> Gas Well <input type="checkbox"/> Dry <input type="checkbox"/> Other b. Type of Completion: <input checked="" type="checkbox"/> New Well <input type="checkbox"/> Work Over <input type="checkbox"/> Deepen <input type="checkbox"/> Plug Back <input type="checkbox"/> Diff. Resrv., Other: _____						5. Lease Serial No. UTU77234			
2. Name of Operator NEWFIELD PRODUCTION COMPANY						6. If Indian, Allottee or Tribe Name			
3. Address ROUTE #3 BOX 3630 MYTON, UT 84052				3a. Phone No. (include area code) Ph: 435-646-3721		7. Unit or CA Agreement Name and No. UTU87538X			
4. Location of Well (Report location clearly and in accordance with Federal requirements)* At surface 2073' FSL 911' FEL (NE/SE) SEC 32 T8S R17E (ML-22069) At top prod. interval reported below 1447' FSL 192' FEL (NE/SE) SEC 32 T8S R17E (ML-22069) At total depth 1086' FSL 280' FWL (SW/SW) SEC 33 T8S R17E (UTU-77234)						8. Lease Name and Well No. GMBU P-33-8-17			
14. Date Spudded 05/19/2014						15. Date T.D. Reached 06/09/2014			
16. Date Completed 06/24/2014 <input type="checkbox"/> D & A <input checked="" type="checkbox"/> Ready to Prod.						9. API Well No. 43-013-51026			
18. Total Depth: MD 6452' TVD 6213'				19. Plug Back T.D.: MD 6394' TVD		10. Field and Pool or Exploratory MONUMENT BUTTE			
20. Depth Bridge Plug Set: MD TVD						11. Sec., T., R., M., on Block and Survey or Area SEC 32 T8S R17E Mer SLB			
21. Type Electric & Other Mechanical Logs Run (Submit copy of each) DUAL IND GRD, SP, COMP. NEUTRON, GR, CALIPER, CMT BOND						12. County or Parish DUCHESNE			
22. Was well cored? <input checked="" type="checkbox"/> No <input type="checkbox"/> Yes (Submit analysis) Was DST run? <input checked="" type="checkbox"/> No <input type="checkbox"/> Yes (Submit report) Directional Survey? <input type="checkbox"/> No <input checked="" type="checkbox"/> Yes (Submit copy)						13. State UT			
17. Elevations (DF, RKB, RT, GL)* 5192' GL 5203' KB									
23. Casing and Liner Record (Report all strings set in well)									
Hole Size	Size/Grade	Wt. (#/ft.)	Top (MD)	Bottom (MD)	Stage Cementer Depth	No. of Sk. & Type of Cement	Slurry Vol. (BBL)	Cement Top*	Amount Pulled
12-1/4"	8-5/8" J-55	24	0'	321'		155 CLASS G			
7-7/8"	5-1/2" J-55	15.50	0'	6441'		225 Econocem		0'	
						450Expandacem			
24. Tubing Record									
Size	Depth Set (MD)	Packer Depth (MD)	Size	Depth Set (MD)	Packer Depth (MD)	Size	Depth Set (MD)	Packer Depth (MD)	
2-7/8"	EOT@6237'	TA@6079'							
25. Producing Intervals									
Formation		Top	Bottom	Perforation Record		Size	No. Holes	Perf. Status	
A) Green River		4418'	6185'	4418' - 6185' MD		0.34	75		
B)									
C)									
D)									
26. Perforation Record									
27. Acid, Fracture, Treatment, Cement Squeeze, etc.									
Depth Interval		Amount and Type of Material							
4418' - 6185' MD		Frac w/ 281,240#s of 20/40 white sand in 2,769 bbls of Lightning 17 fluid, in 4 stages.							
28. Production - Interval A									
Date First Produced	Test Date	Hours Tested	Test Production	Oil BBL	Gas MCF	Water BBL	Oil Gravity Corr. API	Gas Gravity	Production Method
6/24/14	7/4/14	24	➡	79	0	111			2.5 X 1.75 X 24 RHAC
Choke Size	Tbg. Press. Flwg. SI	Csg. Press.	24 Hr. Rate	Oil BBL	Gas MCF	Water BBL	Gas/Oil Ratio	Well Status	
			➡					PRODUCING	
28a. Production - Interval B									
Date First Produced	Test Date	Hours Tested	Test Production	Oil BBL	Gas MCF	Water BBL	Oil Gravity Corr. API	Gas Gravity	Production Method
			➡						
Choke Size	Tbg. Press. Flwg. SI	Csg. Press.	24 Hr. Rate	Oil BBL	Gas MCF	Water BBL	Gas/Oil Ratio	Well Status	
			➡						

*(See instructions and spaces for additional data on page 2)

RECEIVED: Jul. 30, 2014

28b. Production - Interval C

Date First Produced	Test Date	Hours Tested	Test Production	Oil BBL	Gas MCF	Water BBL	Oil Gravity Corr. API	Gas Gravity	Production Method
			→						
Choke Size	Tbg. Press. Flwg. SI	Csg. Press.	24 Hr. Rate	Oil BBL	Gas MCF	Water BBL	Gas/Oil Ratio	Well Status	
			→						

28c. Production - Interval D

Date First Produced	Test Date	Hours Tested	Test Production	Oil BBL	Gas MCF	Water BBL	Oil Gravity Corr. API	Gas Gravity	Production Method
			→						
Choke Size	Tbg. Press. Flwg. SI	Csg. Press.	24 Hr. Rate	Oil BBL	Gas MCF	Water BBL	Gas/Oil Ratio	Well Status	
			→						

29. Disposition of Gas (Solid, used for fuel, vented, etc.)

30. Summary of Porous Zones (Include Aquifers):

Show all important zones of porosity and contents thereof: Cored intervals and all drill-stem tests, including depth interval tested, cushion used, time tool open, flowing and shut-in pressures and recoveries.

31. Formation (Log) Markers
GEOLOGICAL MARKERS

Formation	Top	Bottom	Descriptions, Contents, etc.	Name	Top
					Meas. Depth
				GARDEN GULCH MARK GARDEN GULCH 1	3930' 4130'
				GARDEN GULCH 2 POINT 3	4249' 4531'
				X MRKR Y MRKR	4772' 4812'
				DOUGLAS CREEK MRK BI CARBONATE MRK	4948' 5194'
				B LIMESTONE MRK CASTLE PEAK	5338' 5829'
				BASAL CARBONATE WASATCH	6277' 6408'

32. Additional remarks (include plugging procedure):

33. Indicate which items have been attached by placing a check in the appropriate boxes:

- ☐ Electrical/Mechanical Logs (1 full set req'd.)
 ☐ Geologic Report
 ☐ DST Report
 ☒ Directional Survey
☐ Sundry Notice for plugging and cement verification
 ☐ Core Analysis
 ☒ Other: Drilling daily activity

34. I hereby certify that the foregoing and attached information is complete and correct as determined from all available records (see attached instructions)*

Name (please print) Heather CalderTitle Regulatory TechnicianSignature Heather CalderDate 07/21/2014

Title 18 U.S.C. Section 1001 and Title 43 U.S.C. Section 1212, make it a crime for any person knowingly and willfully to make to any department or agency of the United States any false, fictitious or fraudulent statements or representations as to any matter within its jurisdiction.



NEWFIELD EXPLORATION

**USGS Myton SW (UT)
SECTION 32 T8S, R17E
P-33-8-17
Wellbore #1**

Design: Actual

End of Well Report

16 June, 2014





Payzone Directional

End of Well Report



Sundry Number: 53653 API Well Number: 43013510260000

Company: NEWFIELD EXPLORATION	Local Co-ordinate Reference: Well P-33-8-17
Project: USGS Myton SW (UT)	P-33-8-17 @ 5203.0usft (SS #2)
Site: SECTION 32 T8S, R17E	P-33-8-17 @ 5203.0usft (SS #2)
Well: P-33-8-17	True
Wellbore: Wellbore #1	Minimum Curvature
Design: Actual	EDM 5000.1 Single User Db

Project USGS Myton SW (UT), DUCHESNE COUNTY, UT, USA	System Datum: Mean Sea Level
Map System: US State Plane 1983	
Geo Datum: North American Datum 1983	
Map Zone: Utah Central Zone	

Site SECTION 32 T8S, R17E, SEC 32 T8S, R17E					
Site Position: From:	Lat/Long	0.0 usft	Northing: 7,197,024.42 usft	Latitude: 40° 4' 6.630 N	
Position Uncertainty:			Easting: 2,049,704.59 usft	Longitude: 110° 2' 14.800 W	
			Slot Radius: 13-3/16 "	Grid Convergence: 0.94 °	

Well P-33-8-17, SHL: 40° 4' 22.270 -110° 1' 28.230					
Well Position	+N/-S 0.0 usft	Northing: 7,198,666.12 usft	Latitude: 40° 4' 22.270 N		
	+E/-W 0.0 usft	Easting: 2,053,298.25 usft	Longitude: 110° 1' 28.230 W		
Position Uncertainty	0.0 usft	Wellhead Elevation: 5,203.0 usft	Ground Level: 5,192.0 usft		

Wellbore Wellbore #1					
Magnetics	Model Name	Sample Date	Declination (°)	Dip Angle (°)	Field Strength (nT)
	IGRF2010	5/28/2014	10.92	65.75	52,002

Design Actual					
Audit Notes:					
Version: 1.0	Phase:	ACTUAL	Tie On Depth:	0.0	
Vertical Section:	Depth From (TVD) (usft)	+N/-S (usft)	+E/-W (usft)	Direction (°)	
	0.0	0.0	0.0	127.86	

Survey Program	Date	6/16/2014			
From (usft)	To (usft)	Survey (Wellbore)	Tool Name	Description	
379.0	6,452.0	Survey #1 (Wellbore #1)	MWD	MWD - Standard	



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Site: SECTION 32 T8S, R17E
Well: P-33-8-17
Wellbore: Wellbore #1
Design: Actual

Local Co-ordinate Reference:
TVD Reference: Well P-33-8-17
MD Reference: P-33-8-17 @ 5203.0usft (SS #2)
North Reference: P-33-8-17 @ 5203.0usft (SS #2)
Survey Calculation Method: True
Database: Minimum Curvature
EDM 5000.1 Single User Db

Survey	MD (usft)	Inc (°)	Azi (azimuth) (°)	TVD (usft)	V. Sec (usft)	N/S (usft)	E/W (usft)	DLeg (°/100usft)	Build (°/100usft)	Turn (°/100usft)
	0.0	0.00	0.00	0.00	0.0	0.0	0.0	0.00	0.00	0.00
	379.0	1.98	183.80	378.9	3.7	-6.5	-0.4	0.52	0.52	0.00
	410.0	1.93	185.51	409.9	4.2	-7.6	-0.5	0.25	-0.16	5.52
	441.0	2.42	183.93	440.9	4.9	-8.8	-0.6	1.59	1.58	-5.10
	471.0	2.55	190.88	470.9	5.5	-10.0	-0.8	1.09	0.43	23.17
	502.0	2.98	181.53	501.8	6.3	-11.5	-0.9	2.01	1.39	-30.16
	533.0	3.91	168.38	532.8	7.6	-13.4	-0.7	3.92	3.00	-42.42
	564.0	4.88	158.14	563.7	9.6	-15.6	0.0	4.01	3.13	-33.03
	594.0	6.11	156.77	593.5	12.1	-18.3	1.1	4.12	4.10	-4.57
	625.0	6.42	153.87	624.3	15.1	-21.4	2.5	1.43	1.00	-9.35
	656.0	7.12	150.09	655.1	18.4	-24.6	4.2	2.68	2.26	-12.19
	687.0	7.38	148.64	685.9	22.0	-27.9	6.2	1.03	0.84	-4.68
	717.0	7.43	148.73	715.6	25.7	-31.2	8.2	0.17	0.17	0.30
	748.0	7.47	148.42	746.4	29.4	-34.7	10.3	0.18	0.13	-1.00
	779.0	7.56	147.33	777.1	33.2	-38.1	12.5	0.54	0.29	-3.52
	810.0	7.56	148.90	807.8	37.0	-41.6	14.6	0.67	0.00	5.06
	841.0	7.60	148.60	838.6	40.9	-45.1	16.7	0.18	0.13	-0.97
	871.0	7.60	147.11	868.3	44.6	-48.4	18.8	0.66	0.00	-4.97
	902.0	7.51	147.46	899.0	48.4	-51.9	21.0	0.33	-0.29	1.13
	933.0	7.51	148.42	929.8	52.2	-55.3	23.2	0.40	0.00	3.10
	964.0	7.78	144.63	960.5	56.1	-58.7	25.5	1.84	0.87	-12.23
	994.0	7.95	142.62	990.2	60.1	-62.0	27.9	1.08	0.57	-6.70
	1,025.0	7.87	142.71	1,020.9	64.2	-65.4	30.5	0.26	-0.26	0.29
	1,069.0	8.04	142.84	1,064.5	70.1	-70.3	34.2	0.39	0.39	0.30
	1,113.0	8.48	138.19	1,108.0	76.3	-75.1	38.2	1.82	1.00	-10.57
	1,156.0	8.66	135.07	1,150.6	82.6	-79.8	42.6	1.16	0.42	-7.26
	1,200.0	8.66	134.67	1,194.1	89.2	-84.5	47.3	0.14	0.00	-0.91

Company: NEWFIELD EXPLORATION
Project: USGS Myton SW (UT)
Site: SECTION 32 T8S, R17E
Well: P-33-8-17
Wellbore: Wellbore #1
Design: Actual

Local Co-ordinate Reference:
TVD Reference: Well P-33-8-17
MD Reference: P-33-8-17 @ 5203.0usft (SS #2)
North Reference: P-33-8-17 @ 5203.0usft (SS #2)
Survey Calculation Method: True
Database: Minimum Curvature
 EDM 5000.1 Single User Db

Survey	MD (usft)	Inc (°)	Azi (azimuth) (°)	TVD (usft)	V. Sec (usft)	N/S (usft)	E/W (usft)	DLeg (°/100usft)	Build (°/100usft)	Turn (°/100usft)
	1,244.0	8.79	133.44	1,237.5	95.8	-89.1	52.1	0.52	0.30	-2.80
	1,288.0	8.79	132.69	1,281.0	102.5	-93.7	57.0	0.26	0.00	-1.70
	1,331.0	9.05	132.08	1,323.5	109.2	-98.2	61.9	0.64	0.60	-1.42
	1,375.0	9.05	132.25	1,367.0	116.1	-102.8	67.1	0.06	0.00	0.39
	1,419.0	9.54	131.42	1,410.4	123.1	-107.6	72.4	1.15	1.11	-1.89
	1,463.0	9.59	131.24	1,453.8	130.4	-112.4	77.8	0.13	0.11	-0.41
	1,507.0	9.84	130.63	1,497.1	137.9	-117.3	83.5	0.61	0.57	-1.39
	1,550.0	11.34	125.66	1,539.4	145.8	-122.1	89.7	4.08	3.49	-11.56
	1,594.0	13.14	121.20	1,582.4	155.0	-127.2	97.5	4.62	4.09	-10.14
	1,638.0	14.02	118.85	1,625.2	165.3	-132.4	106.4	2.36	2.00	-5.34
	1,682.0	14.77	120.61	1,667.8	176.1	-137.8	115.9	1.97	1.70	4.00
	1,726.0	15.47	122.15	1,710.3	187.5	-143.8	125.7	1.83	1.59	3.50
	1,769.0	16.00	123.24	1,751.7	199.1	-150.1	135.5	1.41	1.23	2.53
	1,813.0	16.88	124.69	1,793.9	211.5	-157.1	145.8	2.21	2.00	3.30
	1,857.0	17.36	125.66	1,835.9	224.5	-164.5	156.4	1.27	1.09	2.20
	1,901.0	17.53	125.88	1,877.9	237.7	-172.2	167.1	0.41	0.39	0.50
	1,945.0	17.09	124.69	1,919.9	250.7	-179.8	177.8	1.28	-1.00	-2.70
	1,989.0	17.05	125.05	1,962.0	263.6	-187.2	188.4	0.26	-0.09	0.82
	2,032.0	17.58	123.82	2,003.0	276.4	-194.4	199.0	1.50	1.23	-2.86
	2,076.0	17.53	122.80	2,045.0	289.6	-201.7	210.1	0.71	-0.11	-2.32
	2,120.0	18.19	123.77	2,086.8	303.1	-209.1	221.3	1.65	1.50	2.20
	2,164.0	18.33	124.96	2,128.6	316.9	-216.9	232.7	0.91	0.32	2.70
	2,208.0	17.53	123.64	2,170.5	330.4	-224.5	243.9	2.04	-1.82	-3.00
	2,251.0	17.27	121.79	2,211.5	343.2	-231.5	254.7	1.42	-0.60	-4.30
	2,295.0	17.49	122.19	2,253.5	356.3	-238.5	265.9	0.57	0.50	0.91
	2,339.0	17.45	124.65	2,295.5	369.4	-245.7	276.9	1.68	-0.09	5.59
	2,383.0	17.14	126.80	2,337.5	382.5	-253.4	287.5	1.61	-0.70	4.89



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Local Co-ordinate Reference: Well P-33-8-17
 TVD Reference: P-33-8-17 @ 5203.0usft (SS #2)
 MD Reference: P-33-8-17 @ 5203.0usft (SS #2)
 North Reference: True
 Survey Calculation Method: Minimum Curvature
 Database: EDM 5000.1 Single User Db

Survey	MD (usft)	Inc (°)	Azi (azimuth) (°)	TVD (usft)	V. Sec (usft)	N/S (usft)	E/W (usft)	DLeg (°/100usft)	Build (°/100usft)	Turn (°/100usft)
	2,427.0	17.97	126.41	2,379.4	395.8	-261.3	298.2	1.91	1.89	-0.89
	2,470.0	18.41	124.47	2,420.3	409.2	-269.1	309.1	1.74	1.02	-4.51
	2,514.0	19.38	125.71	2,461.9	423.4	-277.2	320.8	2.39	2.20	2.82
	2,558.0	18.63	129.31	2,503.5	437.7	-286.0	332.1	3.16	-1.70	8.18
	2,602.0	19.16	127.38	2,545.2	452.0	-294.8	343.3	1.86	1.20	-4.39
	2,646.0	18.68	128.47	2,586.8	466.2	-303.6	354.6	1.35	-1.09	2.48
	2,690.0	17.62	127.99	2,628.6	479.9	-312.0	365.3	2.43	-2.41	-1.09
	2,733.0	17.27	126.19	2,669.6	492.8	-319.8	375.6	1.50	-0.81	-4.19
	2,777.0	17.14	125.22	2,711.6	505.8	-327.4	386.2	0.72	-0.30	-2.20
	2,821.0	16.17	126.67	2,753.8	518.4	-334.8	396.4	2.40	-2.20	3.30
	2,865.0	16.17	126.10	2,796.1	530.7	-342.1	406.2	0.36	0.00	-1.30
	2,909.0	15.91	126.54	2,838.3	542.8	-349.3	416.0	0.65	-0.59	1.00
	2,952.0	16.28	123.35	2,879.7	554.7	-356.1	425.8	2.23	0.86	-7.42
	2,996.0	18.21	120.49	2,921.7	567.7	-363.0	436.9	4.79	4.39	-6.50
	3,040.0	18.76	120.70	2,963.4	581.5	-370.1	448.9	1.26	1.25	0.48
	3,084.0	19.47	122.63	3,005.0	595.9	-377.7	461.2	2.16	1.61	4.39
	3,128.0	19.51	125.31	3,046.5	610.5	-385.9	473.3	2.03	0.09	6.09
	3,171.0	19.95	126.72	3,086.9	625.0	-394.4	485.1	1.51	1.02	3.28
	3,215.0	19.56	128.96	3,128.3	639.9	-403.5	496.8	1.94	-0.89	5.09
	3,259.0	18.24	126.14	3,170.0	654.1	-412.2	508.1	3.65	-3.00	-6.41
	3,303.0	17.40	125.40	3,211.9	667.6	-420.1	519.0	1.98	-1.91	-1.68
	3,347.0	18.06	125.22	3,253.8	681.0	-427.8	530.0	1.51	1.50	-0.41
	3,390.0	19.20	124.87	3,294.5	694.7	-435.7	541.2	2.66	2.65	-0.81
	3,434.0	19.78	125.97	3,336.0	709.4	-444.2	553.2	1.56	1.32	2.50
	3,478.0	20.17	125.22	3,377.4	724.4	-453.0	565.4	1.06	0.89	-1.70
	3,522.0	20.00	124.43	3,418.7	739.5	-461.6	577.8	0.73	-0.39	-1.80
	3,566.0	19.64	124.34	3,460.1	754.4	-470.0	590.1	0.82	-0.82	-0.20



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Local Co-ordinate Reference:
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Database: Minimum Curvature
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Survey	MD (usft)	Inc (°)	Azi (azimuth) (°)	TVD (usft)	V. Sec (usft)	N/S (usft)	E/W (usft)	DLeg (°/100usft)	Build (°/100usft)	Turn (°/100usft)
	3,610.0	19.64	124.65	3,501.5	769.1	-478.4	602.3	0.24	0.00	0.70
	3,653.0	19.86	127.29	3,542.0	783.6	-486.9	614.0	2.14	0.51	6.14
	3,697.0	19.73	128.12	3,583.4	798.5	-496.0	625.8	0.70	-0.30	1.89
	3,741.0	19.34	128.25	3,624.8	813.3	-505.1	637.4	0.89	-0.89	0.30
	3,785.0	19.07	128.65	3,666.4	827.7	-514.1	648.7	0.68	-0.61	0.91
	3,829.0	18.66	127.89	3,708.0	842.0	-522.9	659.9	1.09	-0.93	-1.73
	3,873.0	18.25	126.68	3,749.8	855.9	-531.4	671.0	1.28	-0.93	-2.75
	3,916.0	17.27	126.06	3,790.7	869.0	-539.2	681.5	2.32	-2.28	-1.44
	3,960.0	17.18	124.12	3,832.8	882.0	-546.7	692.2	1.32	-0.20	-4.41
	4,004.0	16.88	122.76	3,874.8	894.9	-553.8	703.0	1.13	-0.68	-3.09
	4,048.0	16.92	124.25	3,916.9	907.6	-560.8	713.6	0.99	0.09	3.39
	4,092.0	17.25	125.62	3,959.0	920.5	-568.2	724.2	1.18	0.75	3.11
	4,135.0	17.62	126.85	4,000.0	933.4	-575.8	734.6	1.21	0.86	2.86
	4,179.0	17.53	125.97	4,042.0	946.7	-583.7	745.3	0.64	-0.20	-2.00
	4,223.0	17.67	128.12	4,083.9	960.0	-591.7	755.9	1.51	0.32	4.89
	4,267.0	17.97	129.44	4,125.8	973.4	-600.2	766.4	1.14	0.68	3.00
	4,311.0	18.54	129.92	4,167.6	987.2	-609.0	777.0	1.34	1.30	1.09
	4,354.0	18.59	129.35	4,208.3	1,000.9	-617.7	787.6	0.44	0.12	-1.33
	4,398.0	18.59	128.08	4,250.0	1,014.9	-626.5	798.5	0.92	0.00	-2.89
	4,442.0	18.63	125.92	4,291.7	1,029.0	-634.9	809.7	1.57	0.09	-4.91
	4,486.0	18.01	123.44	4,333.5	1,042.8	-642.8	821.1	2.26	-1.41	-5.64
	4,530.0	17.53	124.78	4,375.4	1,056.2	-650.3	832.2	1.43	-1.09	3.05
	4,574.0	17.31	123.77	4,417.4	1,069.3	-657.7	843.1	0.85	-0.50	-2.30
	4,617.0	16.70	123.20	4,458.5	1,081.9	-664.7	853.6	1.47	-1.42	-1.33
	4,661.0	15.56	121.35	4,500.8	1,094.0	-671.2	863.9	2.84	-2.59	-4.20
	4,705.0	16.17	122.37	4,543.1	1,106.0	-677.6	874.1	1.52	1.39	2.32
	4,749.0	16.61	124.69	4,585.3	1,118.4	-684.4	884.5	1.79	1.00	5.27



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End of Well Report

Sundry Number: 53653 API Well Number: 43013510260000



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Site: SECTION 32 T8S, R17E
Well: P-33-8-17
Wellbore: Wellbore #1
Design: Actual

Local Co-ordinate Reference: Well P-33-8-17
TVD Reference: P-33-8-17 @ 5203.0usft (SS #2)
MD Reference: P-33-8-17 @ 5203.0usft (SS #2)
North Reference: True
Survey Calculation Method: Minimum Curvature
Database: EDM 5000.1 Single User Db

Survey

MD (usft)	Inc (°)	Azi (azimuth) (°)	' TVD (usft)	V. Sec (usft)	N/S (usft)	E/W (usft)	DLeg (°/100usft)	Build (°/100usft)	Turn (°/100usft)
4,793.0	16.66	125.75	4,627.5	1,130.9	-691.7	894.8	0.70	0.11	2.41
4,837.0	17.01	124.96	4,669.6	1,143.7	-699.1	905.2	0.95	0.80	-1.80
4,880.0	16.79	125.75	4,710.7	1,156.2	-706.3	915.3	0.74	-0.51	1.84
4,924.0	16.39	128.93	4,752.9	1,168.7	-713.9	925.3	2.25	-0.91	7.23
4,968.0	16.00	130.06	4,795.1	1,181.0	-721.7	934.8	1.14	-0.89	2.57
5,012.0	15.69	126.98	4,837.5	1,193.0	-729.2	944.2	2.04	-0.70	-7.00
5,056.0	15.47	125.35	4,879.9	1,204.8	-736.2	953.7	1.11	-0.50	-3.70
5,099.0	15.78	127.86	4,921.3	1,216.4	-743.1	963.0	1.73	0.72	5.84
5,143.0	15.07	130.58	4,963.7	1,228.1	-750.5	972.1	2.30	-1.61	6.18
5,187.0	13.80	131.86	5,006.3	1,239.0	-757.7	980.4	2.98	-2.89	2.91
5,231.0	12.48	135.94	5,049.1	1,249.0	-764.6	987.6	3.66	-3.00	9.27
5,275.0	11.95	136.96	5,092.1	1,258.2	-771.4	994.0	1.30	-1.20	2.32
5,319.0	12.44	136.21	5,135.2	1,267.4	-778.1	1,000.4	1.17	1.11	-1.70
5,362.0	13.05	135.11	5,177.1	1,276.8	-784.9	1,007.0	1.53	1.42	-2.56
5,406.0	13.10	137.66	5,220.0	1,286.6	-792.1	1,013.9	1.32	0.11	5.80
5,450.0	13.32	137.48	5,262.8	1,296.5	-799.5	1,020.7	0.51	0.50	-0.41
5,494.0	12.79	141.31	5,305.7	1,306.2	-807.1	1,027.1	2.31	-1.20	8.70
5,538.0	13.68	138.45	5,348.5	1,316.1	-814.8	1,033.6	2.51	2.02	-6.50
5,581.0	14.28	136.34	5,390.2	1,326.3	-822.4	1,040.7	1.83	1.40	-4.91
5,625.0	14.68	135.02	5,432.8	1,337.2	-830.3	1,048.3	1.18	0.91	-3.00
5,669.0	15.12	132.47	5,475.3	1,348.5	-838.1	1,056.5	1.79	1.00	-5.80
5,713.0	16.22	132.56	5,517.7	1,360.3	-846.1	1,065.3	2.50	2.50	0.20
5,757.0	16.70	131.81	5,559.9	1,372.8	-854.5	1,074.5	1.19	1.09	-1.70
5,800.0	17.09	129.22	5,601.0	1,385.2	-862.6	1,084.0	1.97	0.91	-6.02
5,844.0	16.66	130.01	5,643.1	1,398.0	-870.7	1,093.9	1.11	-0.98	1.80
5,888.0	17.27	126.63	5,685.2	1,410.8	-878.7	1,103.9	2.64	1.39	-7.68
5,932.0	18.24	125.75	5,727.1	1,424.3	-886.6	1,114.8	2.29	2.20	-2.00



Payzone Directional
End of Well Report



Sundry Number: 53653 API Well Number: 43013510260000

Company: NEWFIELD EXPLORATION
Project: USGS Myton SW (UT)
Site: SECTION 32 T8S, R17E
Well: P-33-8-17
Wellbore: Wellbore #1
Design: Actual

Local Co-ordinate Reference:
TVD Reference:
MD Reference:
North Reference:
Survey Calculation Method:
Database:

Well P-33-8-17
P-33-8-17 @ 5203.0usft (SS #2)
P-33-8-17 @ 5203.0usft (SS #2)
True
Minimum Curvature
EDM 5000.1 Single User Db

Survey

MD (usft)	Inc (°)	Azi (azimuth) (°)	TVD (usft)	V. Sec (usft)	N/S (usft)	E/W (usft)	DLeg (°/100usft)	Build (°/100usft)	Turn (°/100usft)
5,976.0	18.98	126.41	5,768.8	1,438.3	-894.9	1,126.1	1.75	1.68	1.50
6,019.0	20.43	127.33	5,809.3	1,452.8	-903.6	1,137.7	3.45	3.37	2.14
6,063.0	20.57	125.88	5,850.5	1,468.2	-912.8	1,150.1	1.20	0.32	-3.30
6,107.0	20.65	122.72	5,891.7	1,483.6	-921.5	1,162.9	2.53	0.18	-7.18
6,151.0	21.45	120.87	5,932.8	1,499.4	-929.8	1,176.3	2.36	1.82	-4.20
6,195.0	22.50	120.74	5,973.6	1,515.7	-938.2	1,190.4	2.39	2.39	-0.30
6,238.0	22.54	121.75	6,013.3	1,532.1	-946.8	1,204.5	0.90	0.09	2.35
6,282.0	22.41	121.13	6,054.0	1,548.8	-955.6	1,218.9	0.61	-0.30	-1.41
6,326.0	21.67	120.96	6,094.7	1,565.2	-964.1	1,233.0	1.69	-1.68	-0.39
6,370.0	20.65	121.27	6,135.8	1,580.9	-972.3	1,246.6	2.33	-2.32	0.70
6,400.0	20.04	122.67	6,163.9	1,591.3	-977.8	1,255.5	2.60	-2.03	4.67
6,452.0	20.04	122.67	6,212.8	1,609.1	-987.4	1,270.5	0.00	0.00	0.00

Checked By: _____




Approved By: _____

Date: _____



Project: USGS Myton SW (UT)
Site: SECTION 32 T8S, R17E
Well: P-33-8-17
Wellbore: Wellbore #1
Design: Actual

Azimuths to True North
Magnetic North: 10.92°
Magnetic Field
Strength: 52001.9snT
Dip Angle: 65.75°
Date: 5/28/2014
Model: IGRF2010

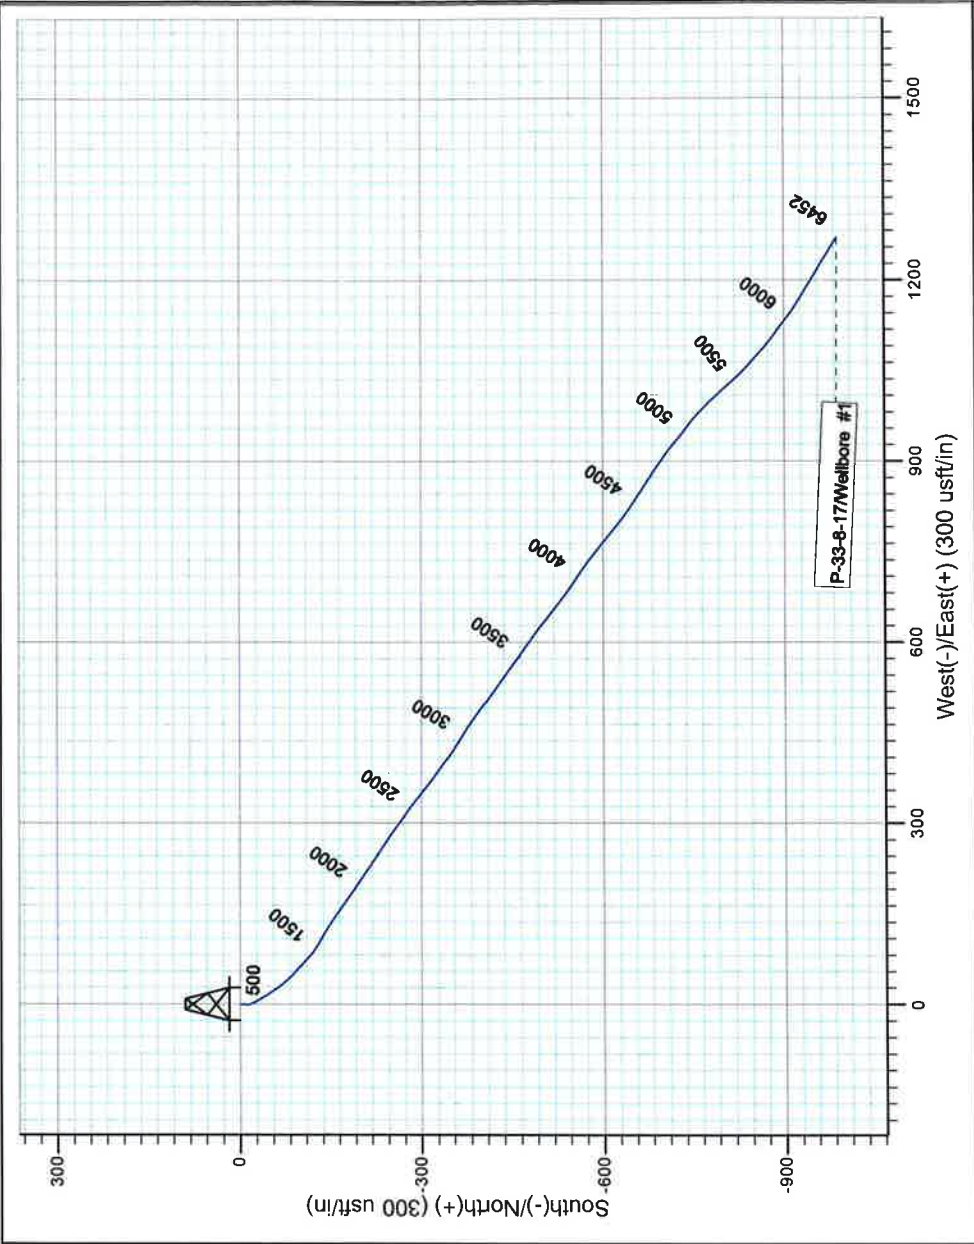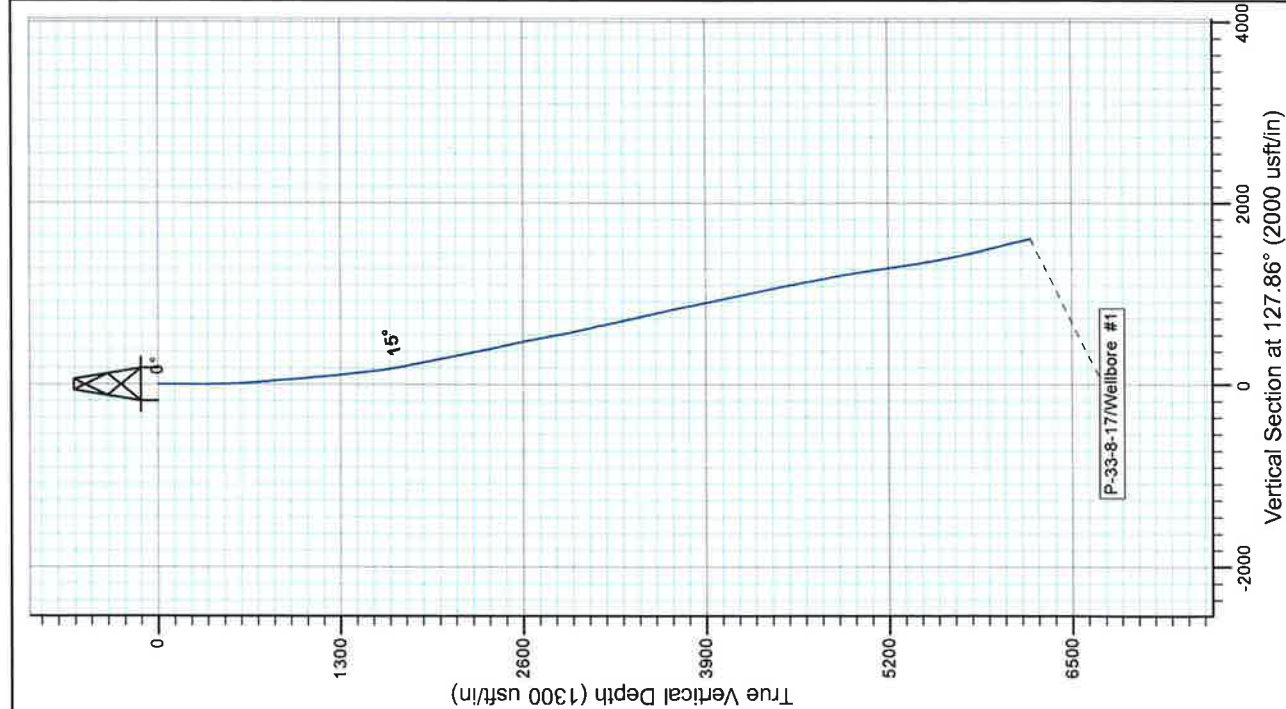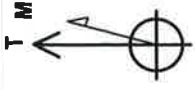

Design: Actual (P-33-8-17/Wellbore #1)

Created By: *Matthew Linton*

Date:

22:13, June 16 2014

THIS SURVEY IS CORRECT TO THE BEST OF
MY KNOWLEDGE AND IS SUPPORTED
BY ACTUAL FIELD DATA



Well Name: GMBU P-33-8-17

Summary Rig Activity

Sundry Number: 53653 API Well Number: 43013510260000

Job Category	Job Start Date	Job End Date

Daily Operations

24hr Activity Summary		
Report Start Date	Report End Date	Run CBL, test csg/BOPS/vlvs and perf stg 1.
6/18/2014	6/19/2014	
Start Time	End Time	Comment
	00:00	11:00
Start Time	End Time	SDFN
	11:00	11:15
Start Time	End Time	Comment
	11:15	11:30
Start Time	End Time	SM
	11:30	11:30
Start Time	End Time	Comment
	11:30	13:00
Start Time	End Time	MIRUWLT, crane and pressure equipment.
	13:00	15:00
Start Time	End Time	Comment
	15:00	16:00
Start Time	End Time	Run CBL Log. ECT @ Surface'. Depth logger 6364'.
	16:00	00:00
Start Time	End Time	Comment
	00:00	08:00
Start Time	End Time	Shut Down for Night
	08:00	08:15
Start Time	End Time	Safety Meeting
	08:15	09:30
Start Time	End Time	MIRU Frac equipment.
	09:30	10:15
Start Time	End Time	Comment
	10:15	11:30
Start Time	End Time	(Stg #1 17# Frac) (CP-5, CP-4) Press test lines to 4800 psi, Open well w/ 95 psi, Break down formation w/ 2 bbls 4% KCL @ 2.7 bpm @ 2341 psi, Bring rate to 23.1 bpm while bullheading 12 bbls 15% HCL & shut down (ISDP 1758 psi, F.G. .73), Frac well w/ 883.9 bbls 17# gel fld, Pumped 80,675# 20/40 white sand in formation, ISIP 1767 psi, F.G. .73, Max press 2986 psi, Avg press 2326 psi, Max rate 39.3, Avg rate 38.9 bpm, (5-min 1441 psi, 10-min 1376 psi, 15-min 1339 psi) Tot pumped 832.9, TFTR 978.6
Start Time	End Time	Comment
	11:30	12:00
Start Time	End Time	(Stg #2), RU The Perforators wireline, Press test lube to 4,000 psi, MU RIH w/ 3 1/8" disposable slick guns (.34 EHD, 120 deg phasing, 16 gram charges, 2 spf) Set WFT 5 1/2" 6K CFTP @ 5570', Perforate A1 sands @ 9494-97', 5483-85', and 5475-76', (18-Holes), POOH RD wireline, SWI
	12:00	13:00
Start Time	End Time	Comment
	13:00	14:00
Start Time	End Time	(Stg #2 17# Frac) (A-1), RU Nabors frac equipment, Press test lines to 4800 psi, Open well w/ 935 psi, Break down formation w/ 1.5 bbls 4% KCL fld @ 4.5 bpm @ 1125 psi, Caught 80% of rate and then shutdown. (ISDP:1112, Fg .65) Frac well w/ 670.8 bbls 17# gel fld, Pumped tll of 70,024# 20/40 white sand in formation, ISIP 1835 psi, F.G. .78, Max press 2634 psi, Avg press 2130 psi, Max rate 39.2, Avg rate 38.9, (5-min 1522 psi, 10-min 1405 psi, 15-min 1401 psi) Tot pumped 616.7, TFTR 1595.3
	14:00	15:00
Start Time	End Time	Comment
	15:00	16:00
Start Time	End Time	(Stg #3), RU The Perforators, Press test lube to 4,000 psi, MU RIH w/ 3 1/8" disposable slick guns (.34 EHD, 180 deg phasing, 16 gram charges, 2 spf) Set WFT 5 1/2" 6K CFTP @ 5170', Perforate D-3, D-1, and DS sands @ 5097-00', 5066-68', 4973-75', and 4868-69' (18-Holes)', POOH RD ireline, SWI
	16:00	17:00



Summary Rig Activity

Sundry Number: 53653 API Well Number: 43013510260000

Start Time	13:00	End Time	13:30	Comment (Stg #3 17# Frac) (D3, D1,DS), RU Nabors frac equipment, Press test lines to 4800 psi, Open well w/ 1009 psi, Break down formation w/ 1.2 bbls 4% KCL @ 4.6 bpm @ 1484 psi, Reached 80% of rate and shut down. ISIP: 1532 FG: .75 Frac well w/ 811.9 bbls gell fld, Pumped tti of 93,059# 20/40 white sand in formation, ISIP 1811 psi, F.G. .80, Max press 2913 psi, Avg press 2347 psi, Max rate 39.2, Avg rate 38.9, (5-min 1610 psi, 10-min 1544 psi, 15-min 1463 psi) Pumped 756.2 bbls, BWTR 2351.5
Start Time	13:30	End Time	14:30	Comment (Stg #4), RU The Perforators wireline, Press test lube to 4,000 psi, MU RIH w/ 3 1/8" disposable slick guns (.34 EHD, 180 deg phasing, 16 gram charges, 3 sprf) Set WFT 5 1/2" 6K CFTP @ 4570', Perforate GB-6, and GB 4 sands @ 4498-00', 4492-94', 4482-84', and 4418-19' (21-Holes), POOH RD wireline, SWI
Start Time	14:30	End Time	15:00	Comment (Stg #4 17# Frac) (GB-6, GB-4), RU Nabors frac equipment, Press test lines to 4800 psi, Open well w/ 1250 psi, Break down formation w/ .8 bbls gell fld @ 3.9 bpm @ 1360 psi, Reached 80% rate and shutdown. NO shut down for ISDP. Frac well w/ 593.3 bbls, Pumped tti of 55,416# 20/40 white sand in formation, ISIP 1799 psi, F.G. .85 Max press 2832 psi, Avg press 2444 psi, Max rate 43.2, Avg rate 42.9, (5-min 1669 psi, 10-min 1625 psi, 15-min 1603 psi) Pumped 562.6 bbls, BWTR 2914.1
Start Time	15:00	End Time	19:00	Comment RDMO Nabors Frac crew and equip. Open well to flowback tanks @ approx 3 bpm. Well flowed for 4 hours and died. Recovered 720 bbls, 2194.1 bbls left to recover.
Start Time	19:00	End Time	00:00	Comment SWIFN
Report Start Date 6/20/2014	Report End Date 6/21/2014	24hr Activity Summary MIRUWOR, ND frac vlv, NU BOPS, PT, RIH to DO/CO through two plgs. Circ cln. SDFWE		
Start Time	00:00	End Time	06:00	Comment Shut Down for Night
Start Time	06:00	End Time	06:30	Comment Safety Meeting
Start Time	06:30	End Time	09:30	Comment Rig up ck pres on csg 500psi open to the pit 45 mins was dead unload tbg off trailer onto racks drift and tally ND frac valve NU double pipe rams.
Start Time	09:30	End Time	10:15	Comment Tried to pressure up on pipe rams and failed the hold pressure. Wait on new ram blocks.
Start Time	10:15	End Time	11:30	Comment Use B&C to pressure test DO Stack. All PT tests good.
Start Time	11:30	End Time	15:00	Comment MU RIH w/ new 4 3/4" chomp bit bit sub PU pipe tag fill @ 4469' RU RBS swivel.
Start Time	15:00	End Time	16:00	Comment Clean out 101' of fill tag 1st plg @4570' 15:40pm drilled through 15:55pm 15 mins.
Start Time	16:00	End Time	17:15	Comment cont circ wells giving up sand 16:20pm cont PU pipe tag fill @5090' clean out 80' tag 2nd plg @5170' 17:00pm drilled through 17:20pm 20mins.
Start Time	17:15	End Time	18:00	Comment Circ well clean EOT @5177' hang back swivel SWIFN.
Start Time	18:00	End Time	18:15	Comment Clean & Secure Lease
Start Time	18:15	End Time	00:00	Comment Shut Down for Night
Report Start Date 6/23/2014	Report End Date 6/24/2014	24hr Activity Summary Finish DO/CO to PBTD, Circ cln and rnd trip prod. Land tbg, ND BOPS, NU WH, X-over to run rods. SWIFN.		
Start Time	00:00	End Time	06:30	Comment Shut Down for Night



Summary Rig Activity

Start Time	06:30	End Time	07:00
Safety Meeting			
Start Time	07:00	End Time	08:45
500psi csg 350psi on tbg RU pump circ 140bbbls wells dead cont PU pipe tag plg w/ jt #169 @5570'.			
Start Time	08:45	End Time	09:15
Drilled through plug 26mins.			
Start Time	09:15	End Time	09:45
hang back swivel cont PU pipe tag fill w/ jt 182 @6001'.			
Start Time	09:45	End Time	13:00
CO 393' to PBTD @6394'.			
Start Time	13:00	End Time	15:00
Circ well bore clean w/ 160bbl rack out RBS swivel LD 6jts.			
Start Time	15:00	End Time	19:00
TOOH w/ 188jts LD 4 3/4" chomp bit TIH w/ perge valve 2jts. 3.50 Desander. 1-4'x2 7/8" tbg sub. 1 jt. PSN. 1 jt. 5 1/2" TAC. 184 jts land tbg w/ hanger RD floor ND bops PU set TAC @6078' w/ 18,000 tension land w/ tbg hanger NU WH PSN @6114' EOT@6236'.			
Start Time	19:00	End Time	19:30
Clean & Secure Lease			
Start Time	19:30	End Time	00:00
Shut Down for Night			
Report Start Date	6/24/2014	Report End Date	6/25/2014
24hr Activity Summary			
Run pump and rods. PWOP.			
Start Time	00:00	End Time	06:30
Shut Down for Night			
Start Time	06:30	End Time	07:00
Safety Meeting			
Start Time	07:00	End Time	10:00
Production Engineer never indicated which company to get a pump from and the rod pump email never got sent to Weatherford w/ detailed design so a breakdown in communication caused a delay in the pump being delivered from the preferred company.			
Start Time	10:00	End Time	12:30
PU prime new Weatherford pump 2.5x1.75x20x23x24' RHAC API/call (Double) MSL 218" RIH w/ 30-7/8" 8pers 133-3/4" 4pers 79-7/8" 8pers 1-8' 1-6' 1-4' 1-2'x7/8' ponys seat pump w/ 1 1/2x36' SM pol rod			
Start Time	12:30	End Time	13:30
Hang head fill tbg w/ 12bbbls stroke test pump to 800psi good.			
Start Time	13:30	End Time	14:30
RDMO (let pump put well on production 5SPM 144"SL)			
Start Time	14:30	End Time	15:00
Clean up location and put well on production.			